


Appendix 1-1 – Application Drawings

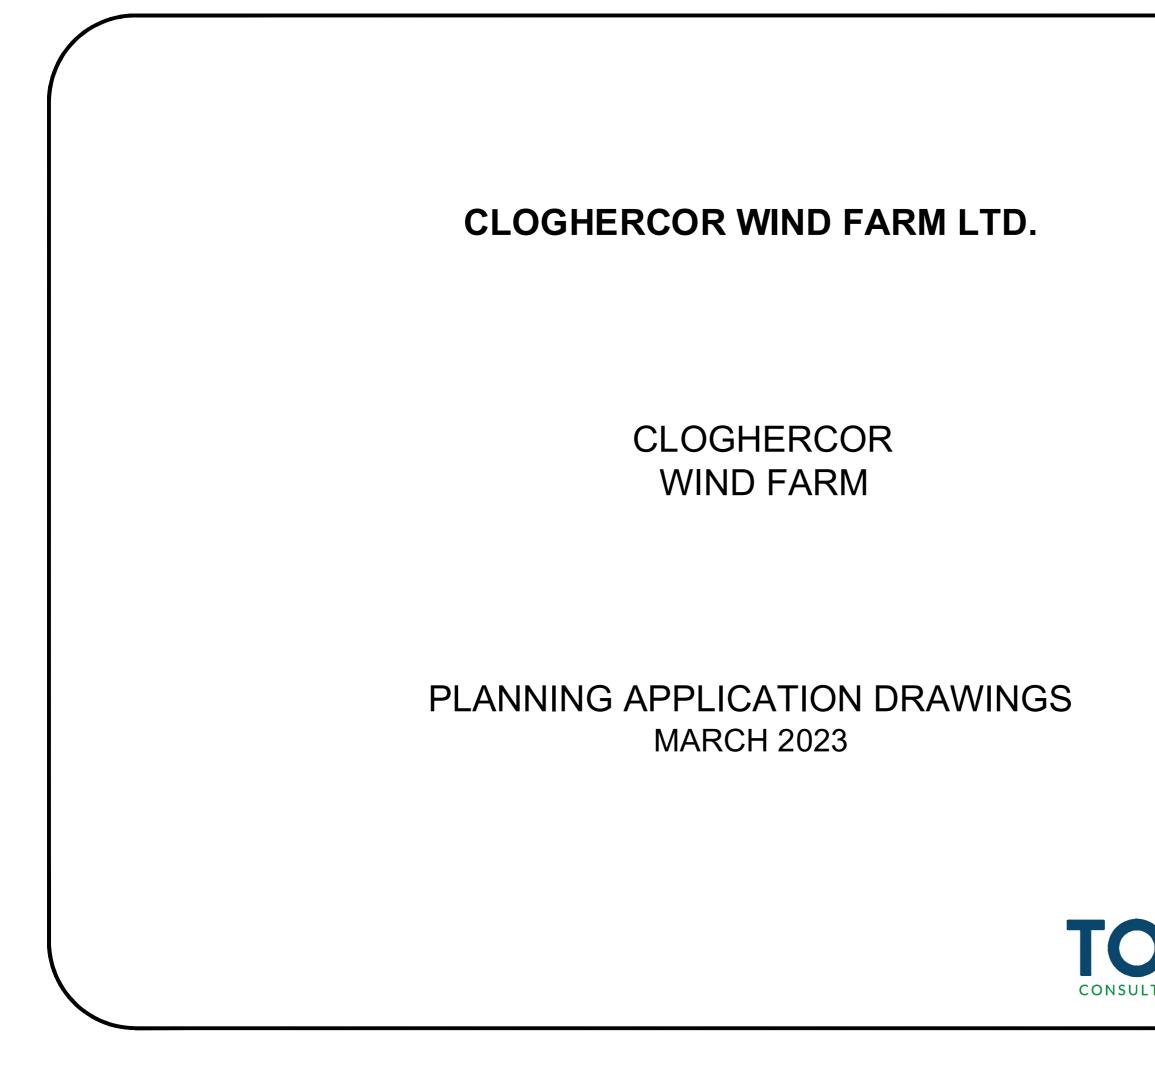







CLOGHERCOR WIND FARM - PLANNING DRAWINGS


	SITE DRAWINGS
10798-2000	Regional Site Location Map
10798-2001	Site Location Map - Sheet 1 of 2
10798-2002	Site Location Map - Sheet 2 of 2
10798-2003	Site Master Plan
10798-2004	Site Layout Plan - Sheet 1 of 3
10798-2005	Site Layout Plan - Sheet 2 of 3
10798-2006	Site Layout Plan - Sheet 3 of 3
10798-2025	Proposed Temporary Site Compound & Elevations
10798-2026	Turbine Hardstand Layout
10798-2027	Turbine Details
10798-2028	Road Construction Details
10798-2029	Road Swales & Settlement Pond Details
10798-2030	Culvert Details
10798-2031	Met Mast Details
10798-2032	Proposed Self Contained Temporary Wheelwash System Details
10798-2040	Road Construction Type Locations
10798-2041	Amenity Car Park Locations and Layout
10798-2042	Vehicular Traffic Entrance details & Visibility Sightlines
10798-2043	Amenity Car Park Entrance details & Visibility Sightlines
10798-2050	Proposed on Site Borrow Pit Details
10798-2051	TDR Areas Master Location Plan
10798-2052	TDR Area 1 Layout Plan
10798-2053	TDR Area 2 Layout Plan
10798-2054	TDR Area 3 Layout Plan
10798-2055	TDR Area 4 Layout Plan
10798-2056	TDR Area 5 Layout Plan
10709 2000	Drainage Lawout Sheet 1 of C
10798-2060	Drainage Layout - Sheet 1 of 6
10798-2061 10798-2062	Drainage Layout - Sheet 3 of 6
10798-2062	Drainage Layout - Sheet 3 of 6 Drainage Layout - Sheet 4 of 6
10798-2063	Drainage Layout - Sheet 4 of 6 Drainage Layout - Sheet 5 of 6
10798-2064	Drainage Layout - Sheet 6 of 6
107 30-2003	
10798-2070	Site Amenity / Recreation Plan


	ELECTRICAL DETAIL DRAWI
05725-DR-100	Overall Site Location Map
05725-DR-101	Site Layout (Sheet 1 of 2)
05725-DR-102	Site Layout (Sheet 2 of 2)
05725-DR-107	SW End Mast Detail
05725-DR-108	147A - 162A Sectional Views
05725-DR-109	Tower 1491ET Earth Ring
05725-DR-110	Cloghercor SS Site Layout
05725-DR-111	Cut and Fill Area Layout Plan
05725-DR-112	Compound Sections Cut & Fill Areas
05725-DR-113	Substation Compound Elevations &
05725-DR-114	Gate & Fencing Details
05725-DR-115	Site Compound details & Access Ro
05725-DR-116	18m Lightning Monopole
05725-DR-117	23m Telecom pole
05725-DR-118	EirGrid Control Building - Plan/Elev
05725-DR-119	IPP Building - Plan/Elevations/Sections
05725-DR-120	Typical Ducting Through Regional/L
05725-DR-121	Ducting through existing Floating R
05725-DR-124	Ditch/Drain Crossing Detail
05725-DR-125	Typical Comms Chamber Detail
05725-DR-126	Typical Link Box Chamber Detail
05725-DR-127	Joint Bay Section Detail
05725-DR-128	Joint Bay Arrangement Detail
05725-DR-129	Culvert/Service Crossing Detail
05725-DR-130	Watermain Crossing Detail
05725-DR-131	HDD Detail - Stream Crossing No.1
05725-DR-132	HDD Detail - Stream Crossing No.2
05725-DR-133	Typical Transition Chamber Detail
05725-DR-134	Substation Drainage details
05725-DR-135	Rainwater Harvesting Tank
05725-DR-136	Substation Layout Plan with Vehicle


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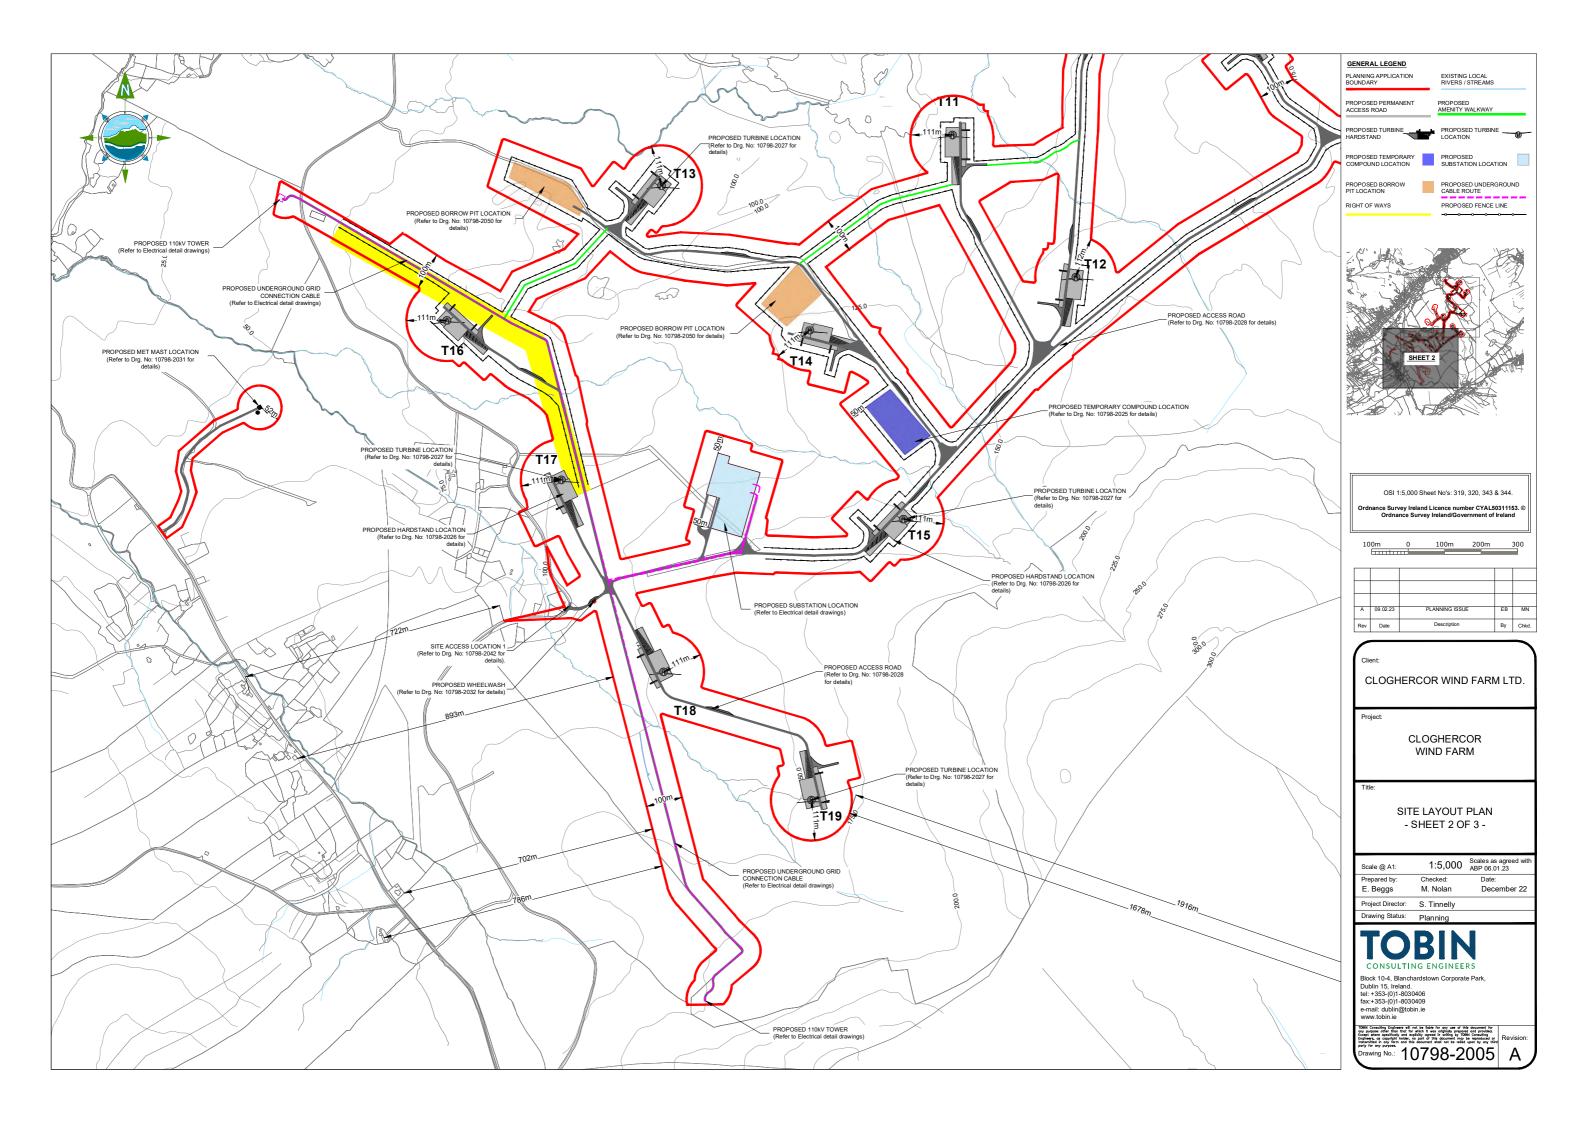


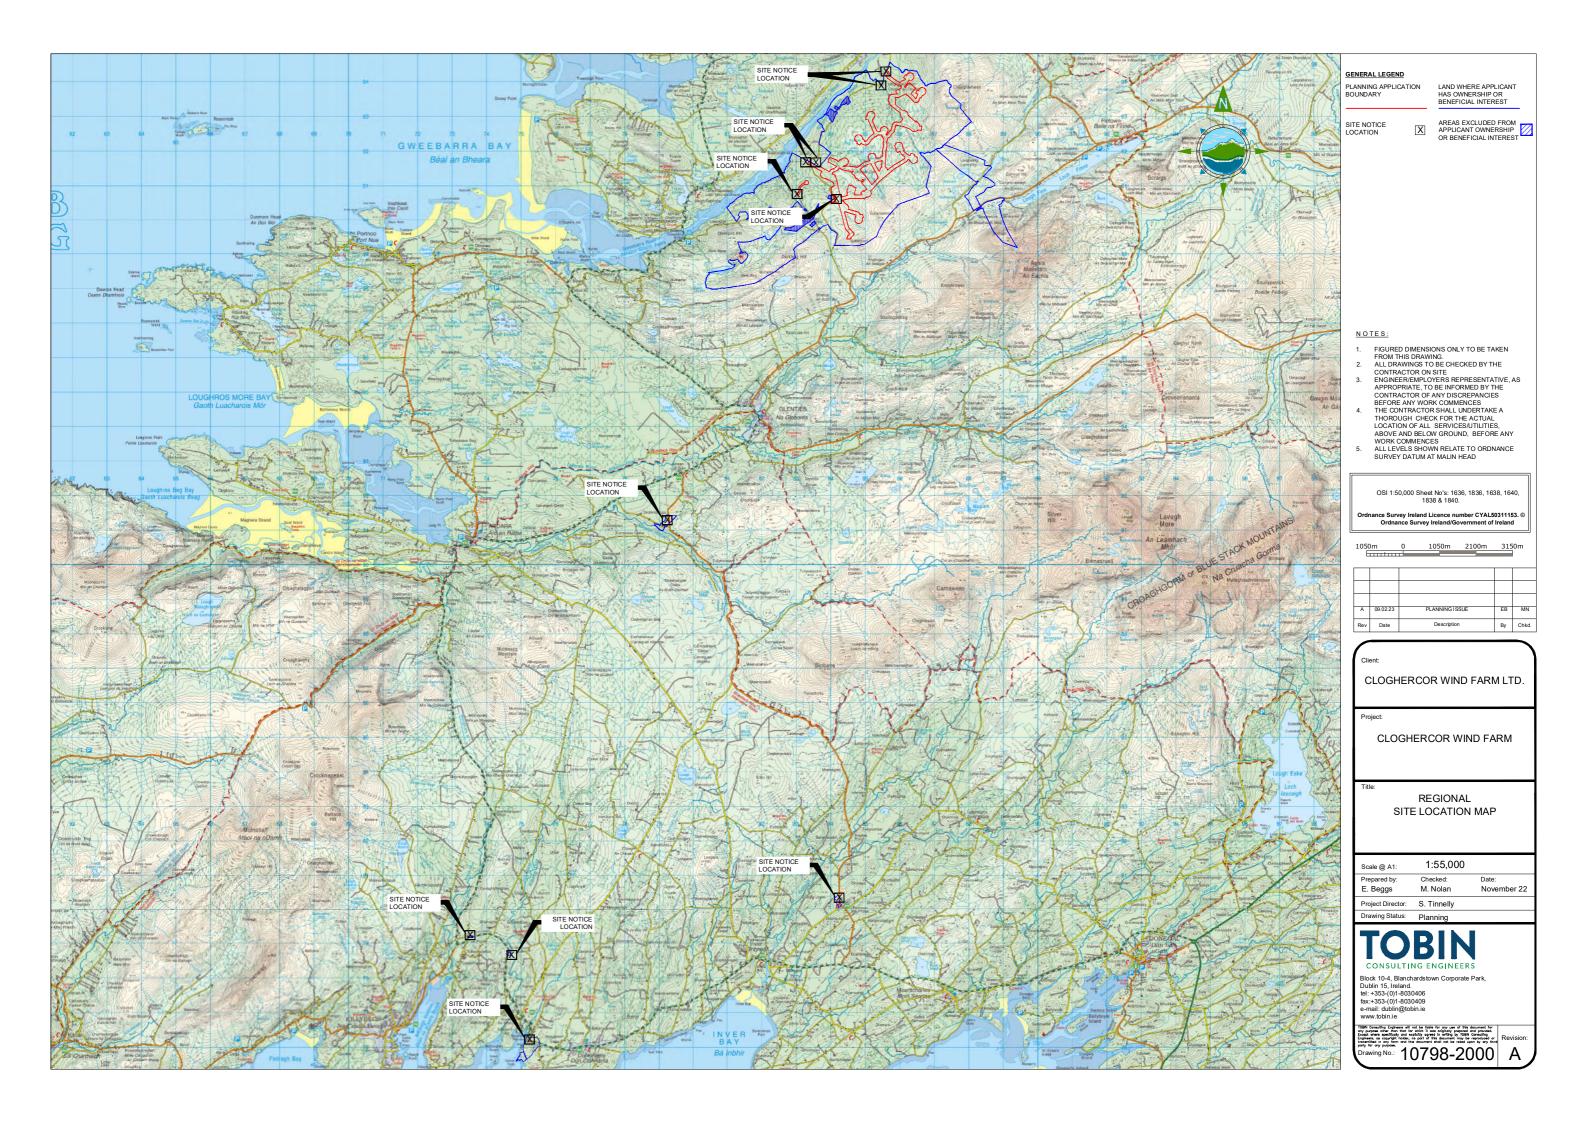


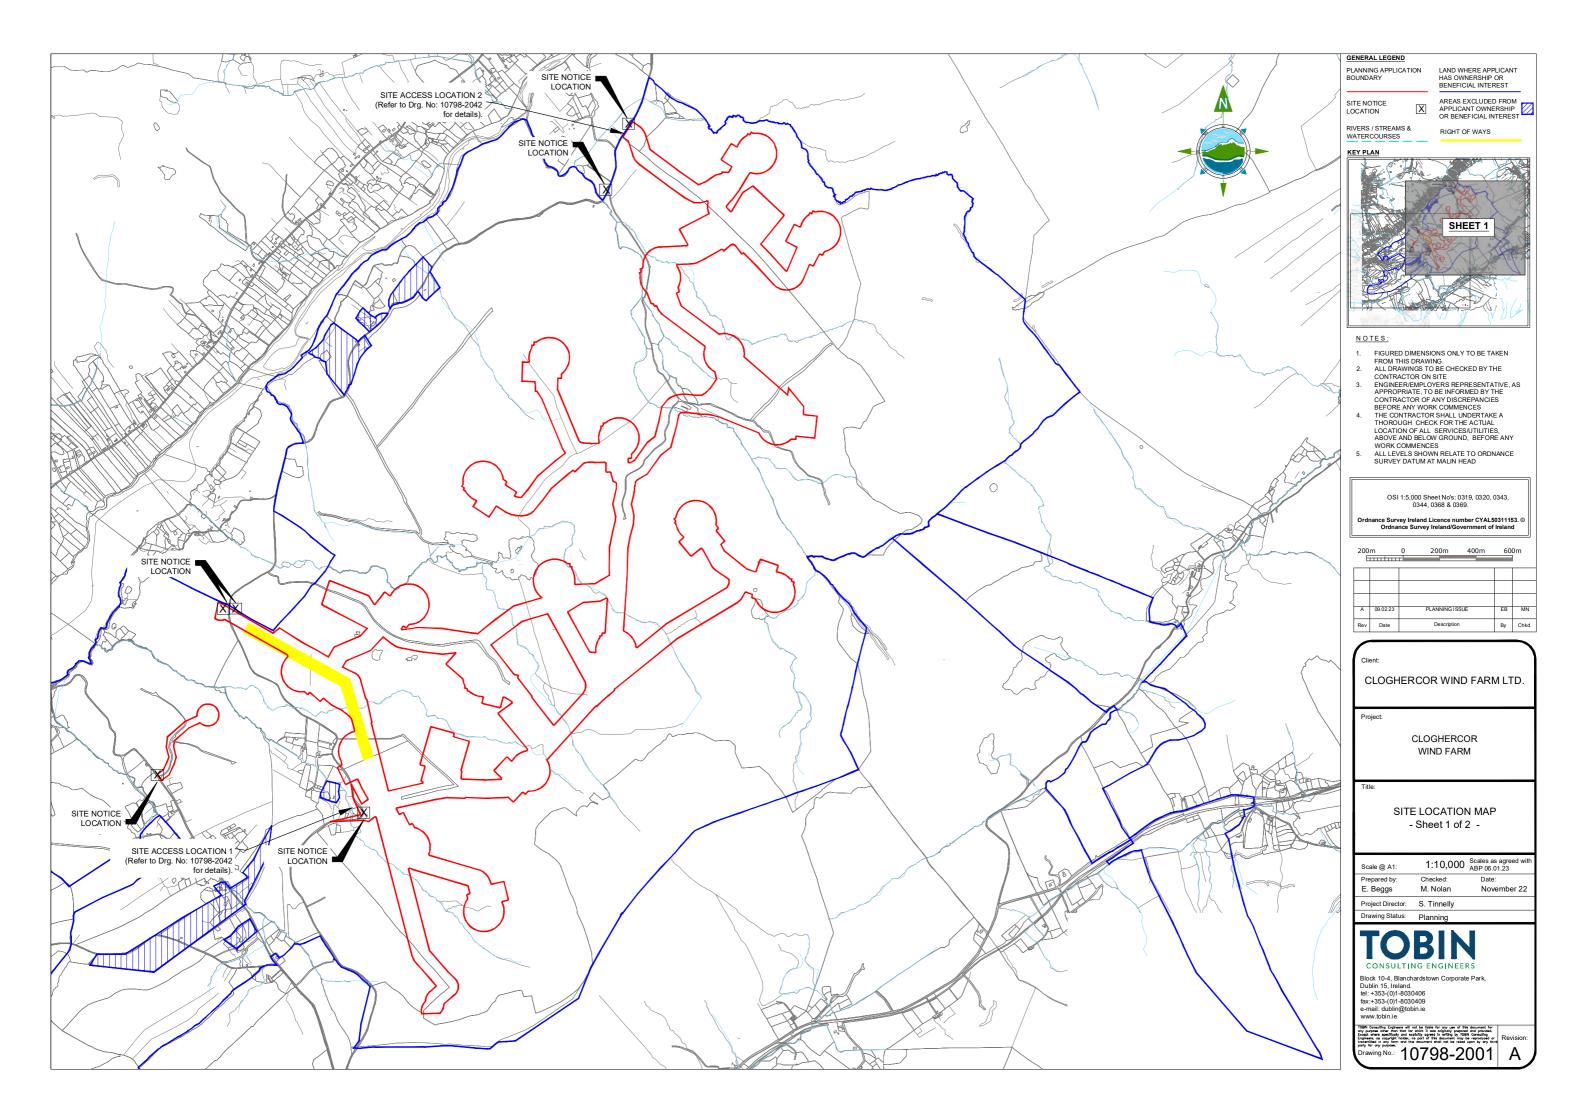


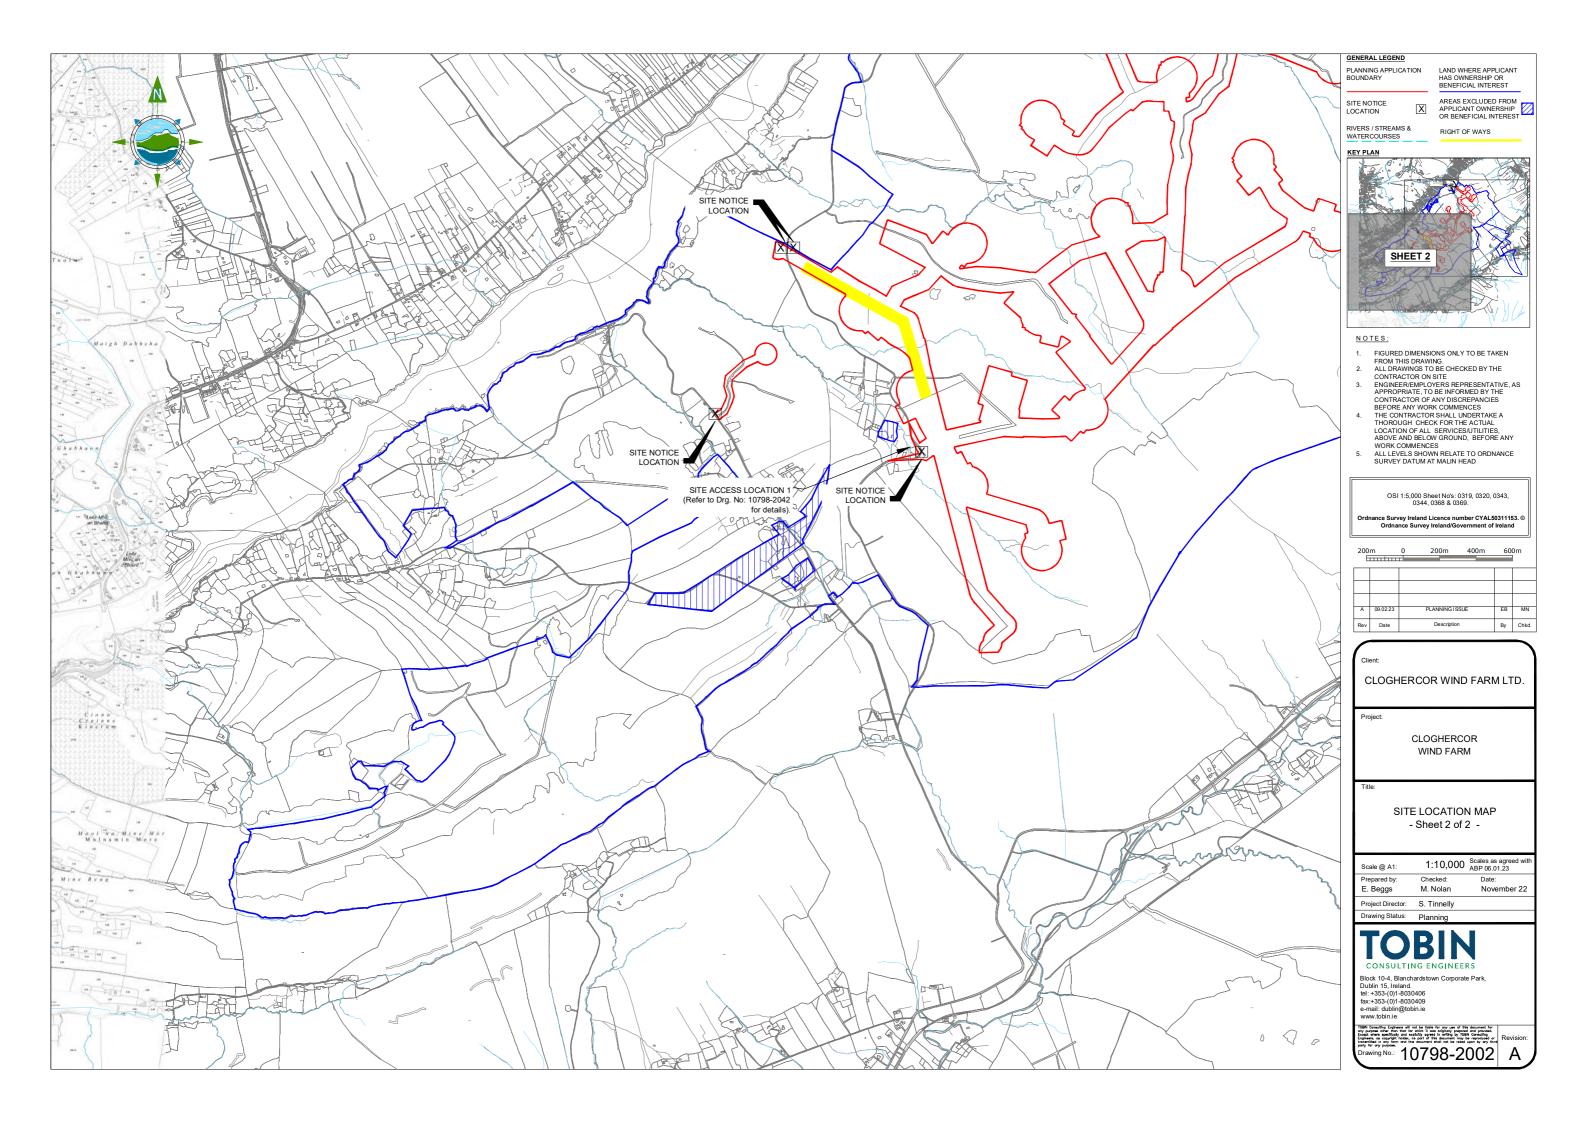

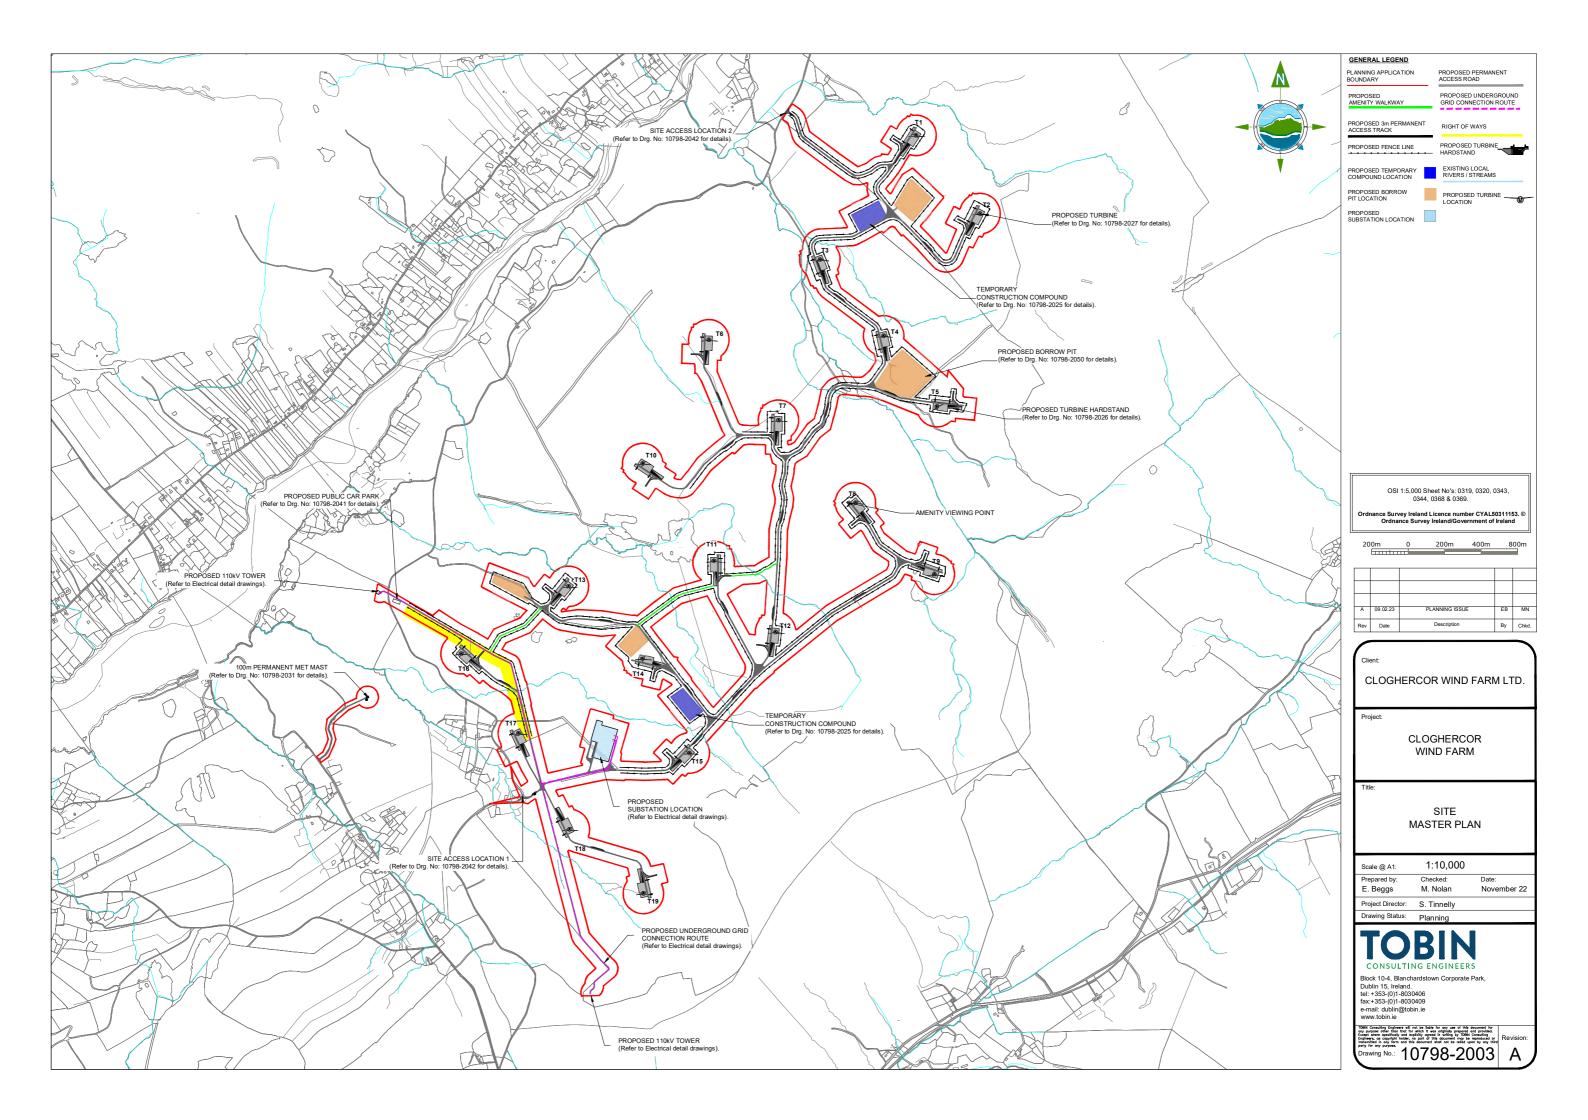


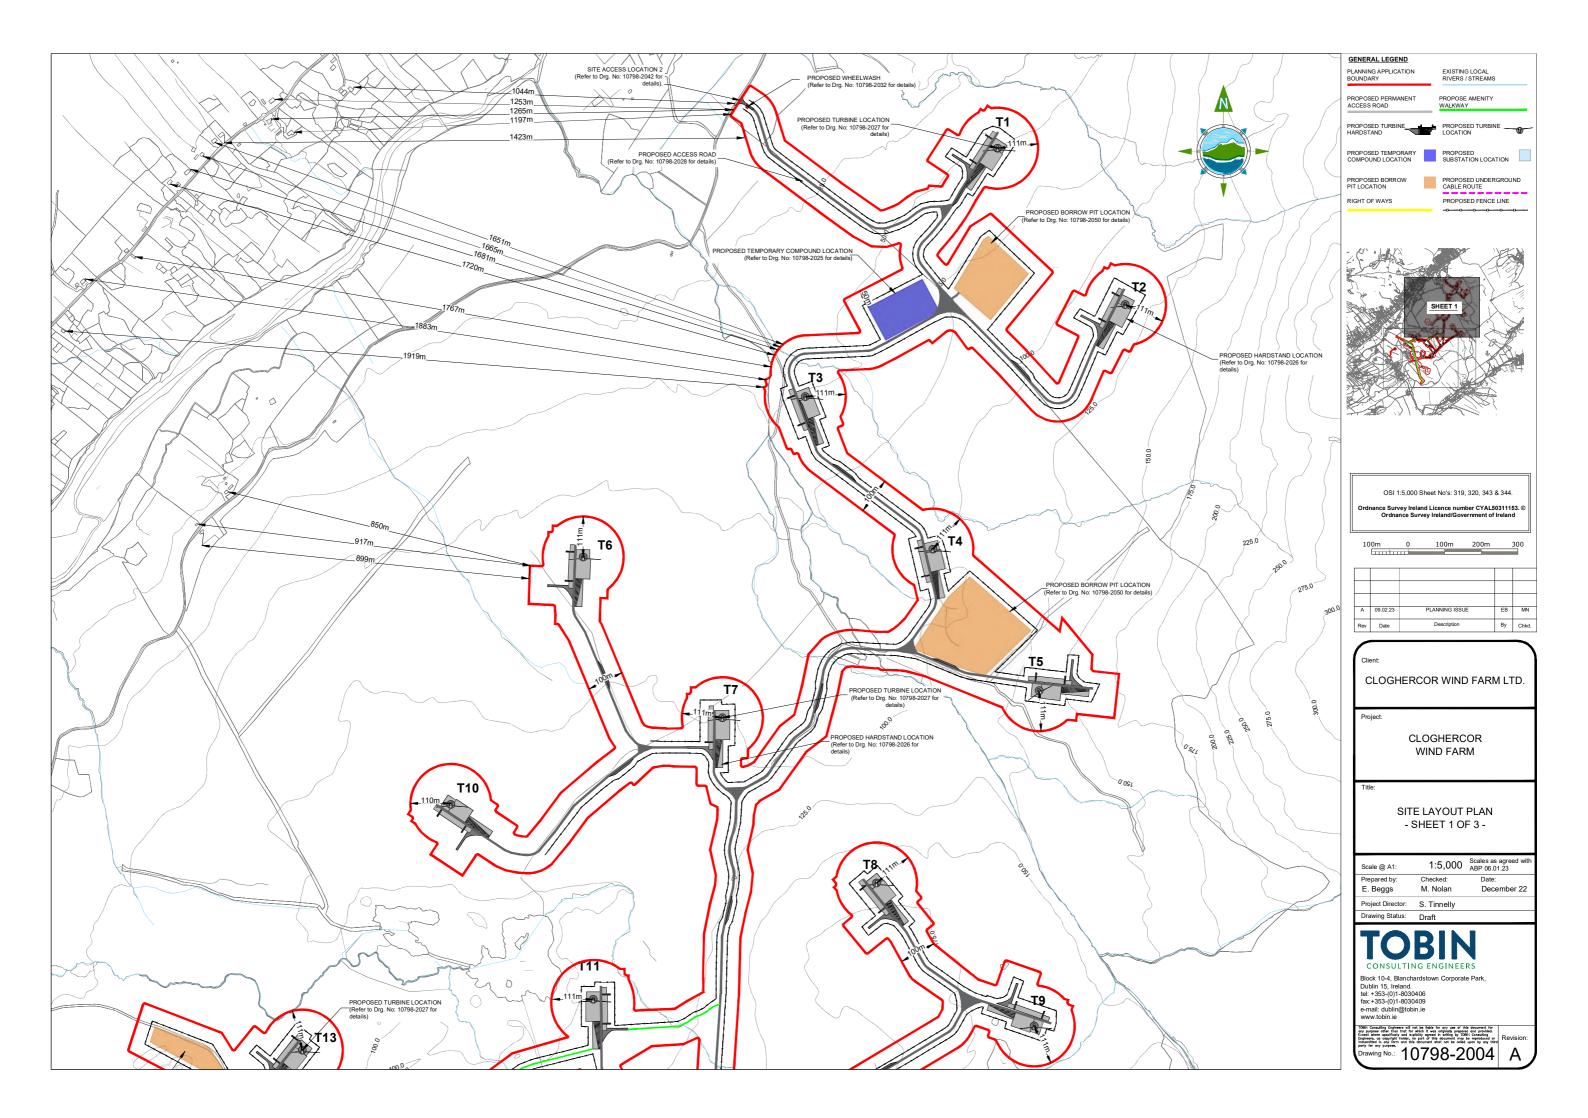

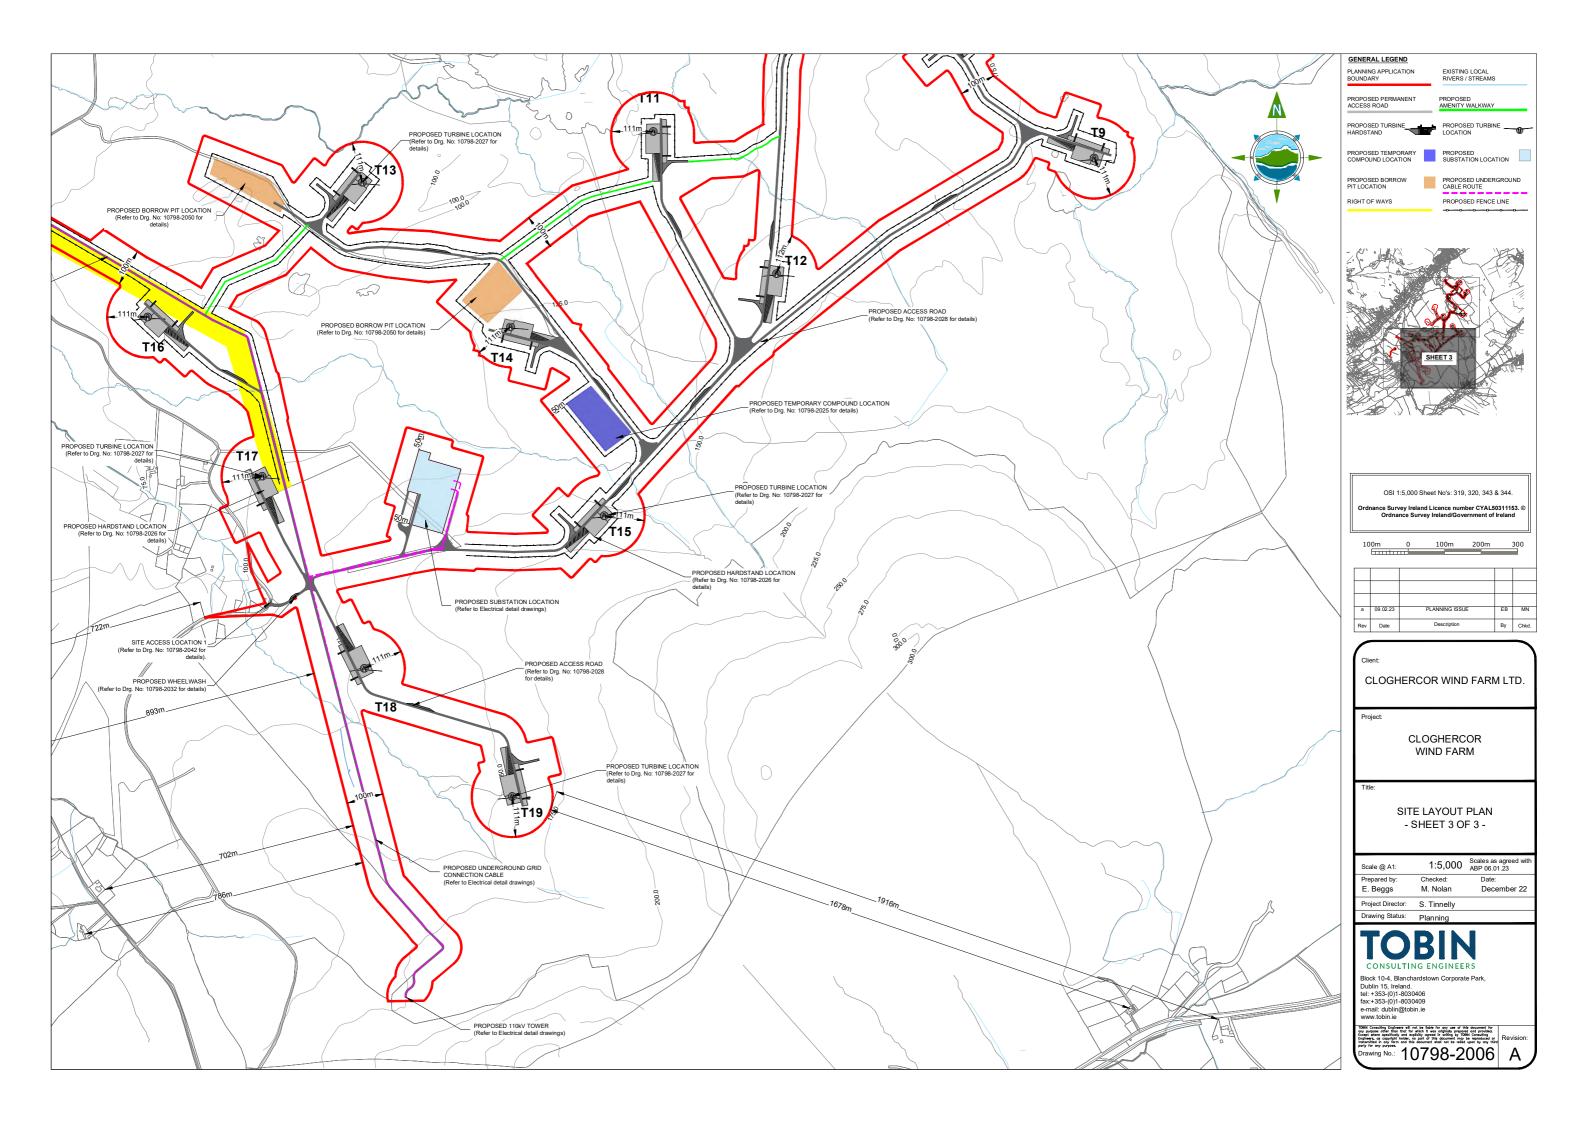

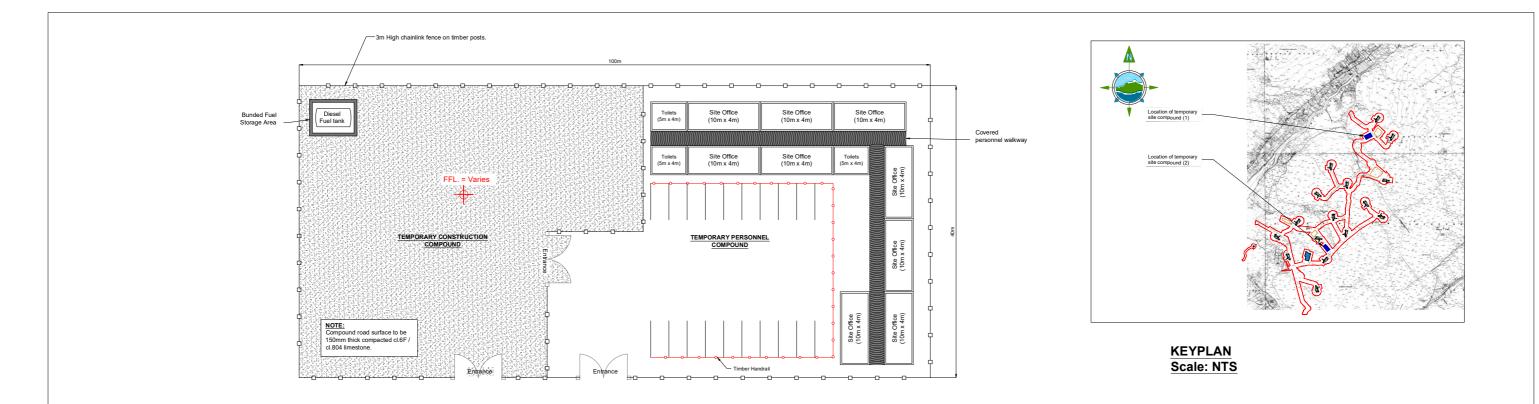


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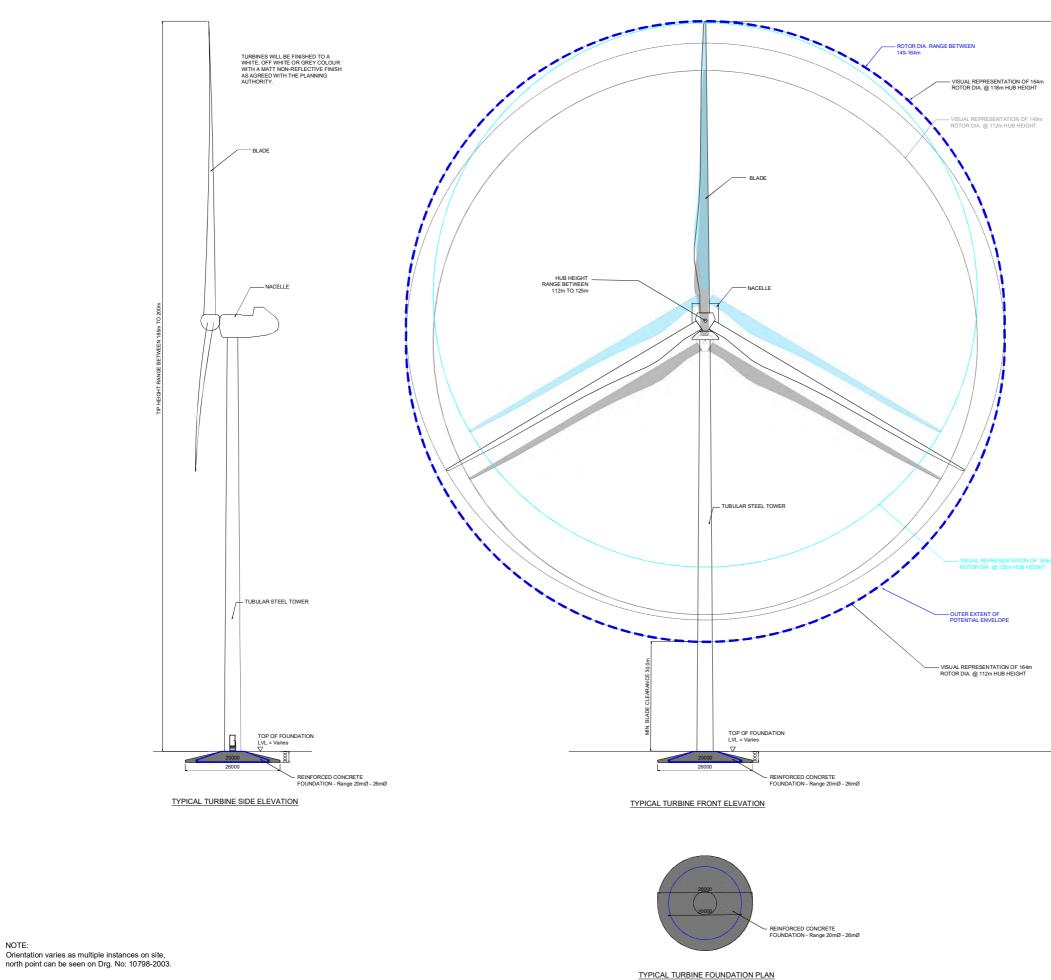

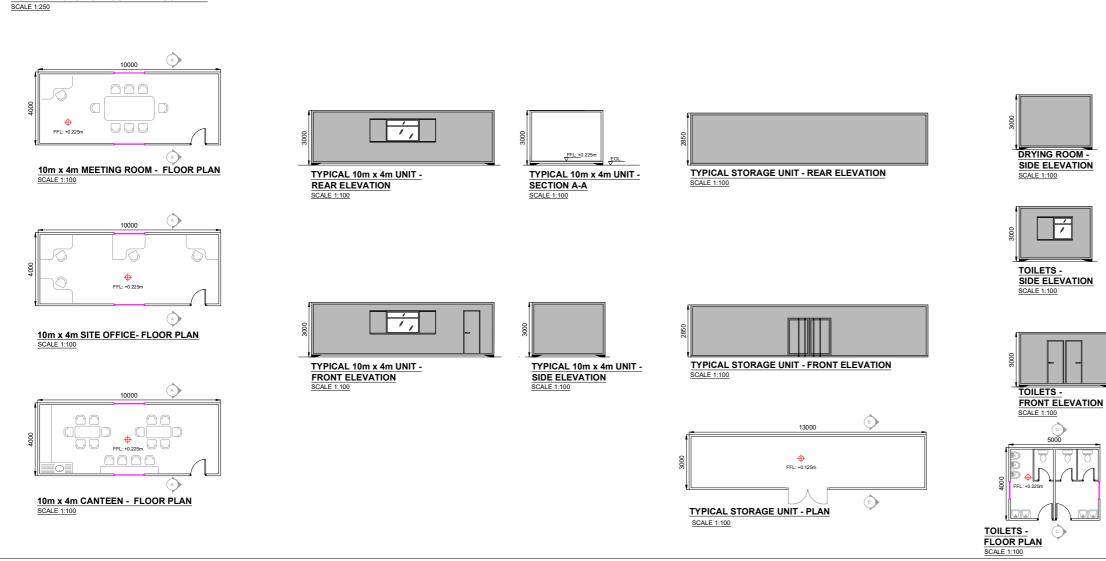
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Rev	Date	Description	Ву	Chkd.


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NOTE:




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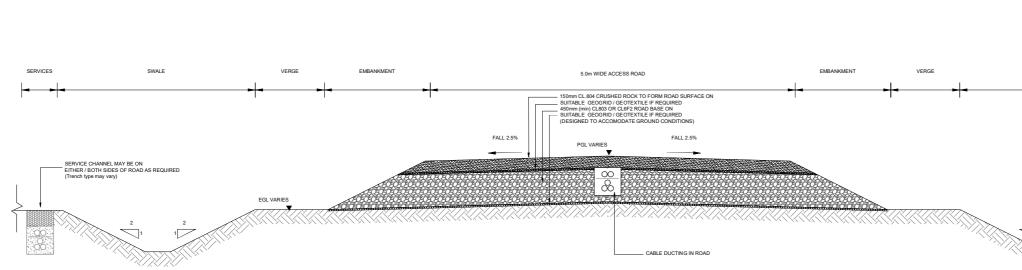
CLOGHERCOR WIND FARM LTD.
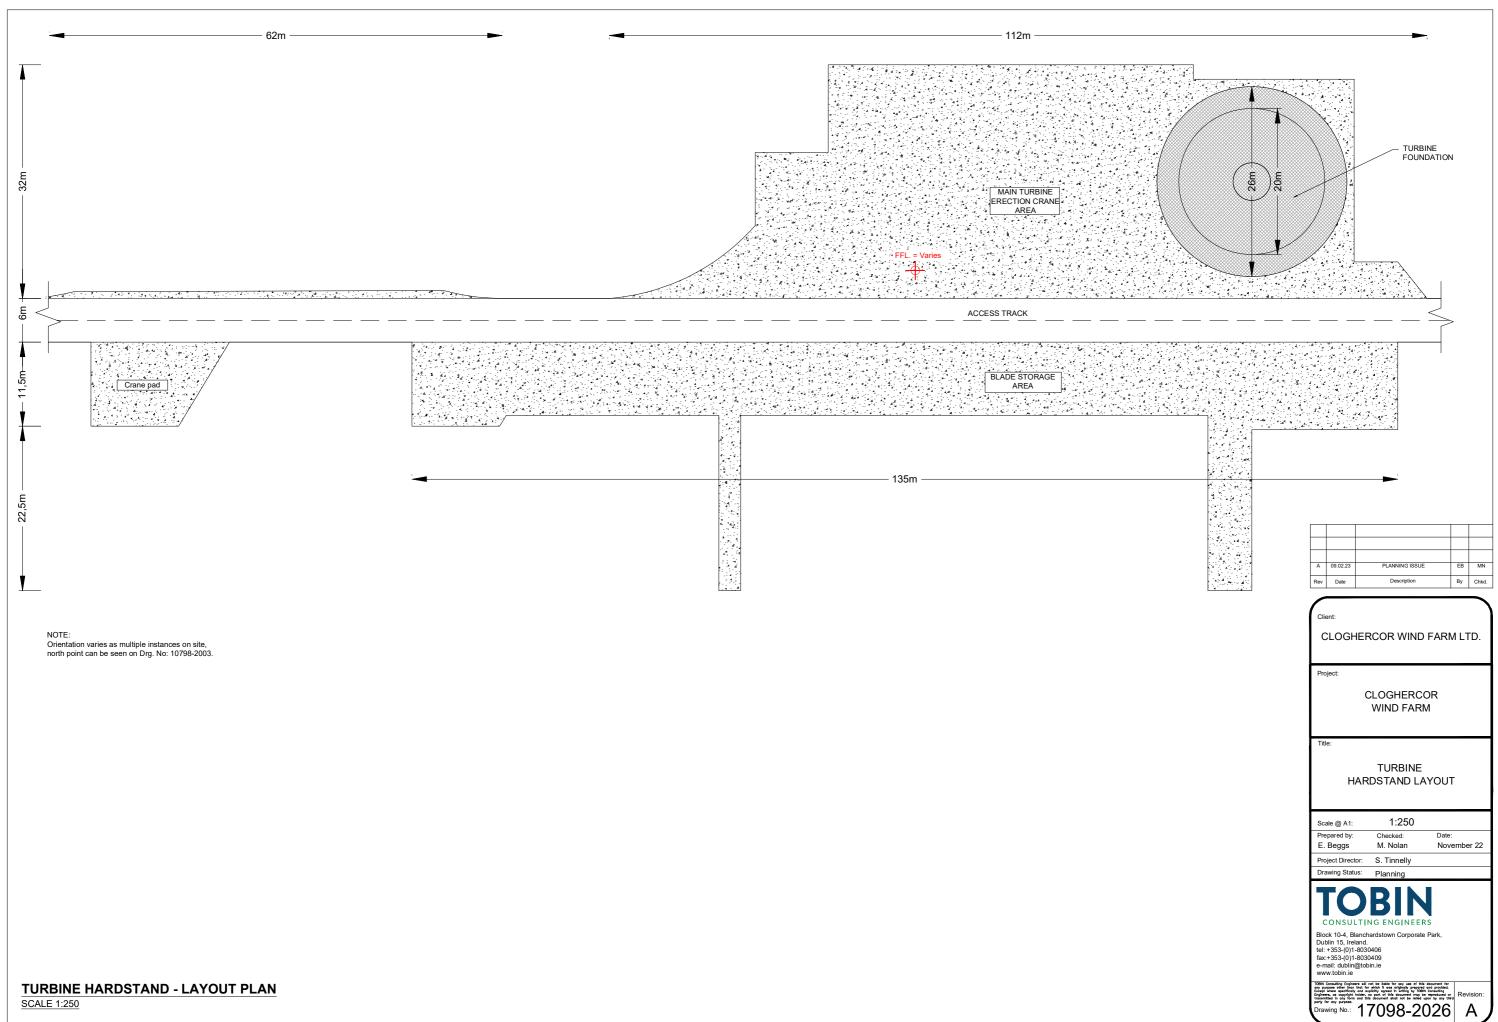
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A	09.02.23	PLANNING ISSUE	EB	MN
Rev	Date	Description	By	Chkd.


TYPE 3 - 1 - 2m AMENITY ONLY ACCESS ROAD CROSS SECTION FLOATING ROAD

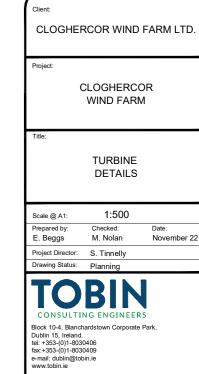


TYPE 2 - 5.0m CONSTRUCTION TRAFFIC ACCESS ROAD CROSS SECTION FLOATING ROAD

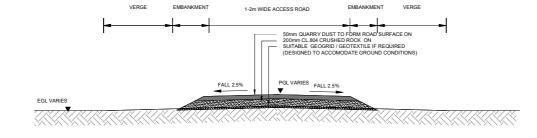



TYPE 1 - 5.0m CONSTRUCTION TRAFFIC ACCESS ROAD CROSS SECTION EXCAVATE & REPLACE

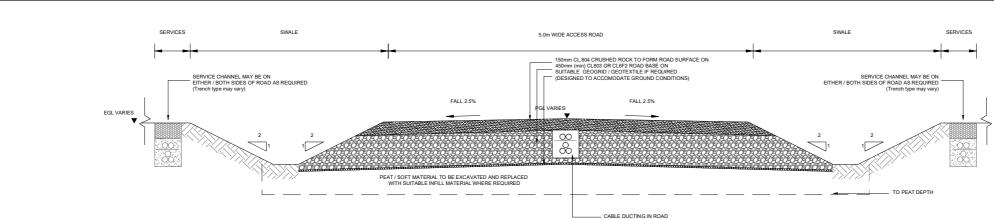


EGL VARIES	
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SERVICE CHANNEL MAY BE ON EITHER / BOTH SIDES OF ROAD AS REQUIRED (Trench type may vary)	
	A 09.02.23 PLANNING ISSUE EB MN Rev Date Description By Chkd.
	CLOGHERCOR WIND FARM LTD. Project: CLOGHERCOR WIND FARM Title: ROAD CONSTRUCTION DETAILS
	Scale @ A1: 1:25 Prepared by: Checked: Date: E. Beggs M. Nolan November 22 Project Director: S. Tinnelly Drawing Status: Planning
	TCOBBING CONSULTING ENGINEERS Block 10-4, Blanchardstown Corporate Park, Dublin 15, 1refand. 1te: 4353-(0)1-8030409 fax:4353-(0)1-8030409 e-mail: uublin@tobin.ie www.tobin.ie Twistick.comments of the factor of the deciment for programments of the factor of the deciment for programments of the factor of the deciment for programments of the deciment for the deciment for programment for the deciment for the deciment for the deciment for programment for the deciment for the deciment for the deciment for programment for the deciment for the deciment for the deciment for programment for the deciment for the deciment for the deciment for the deciment for programment for the deciment for the deciment for the deciment for programment for the dec

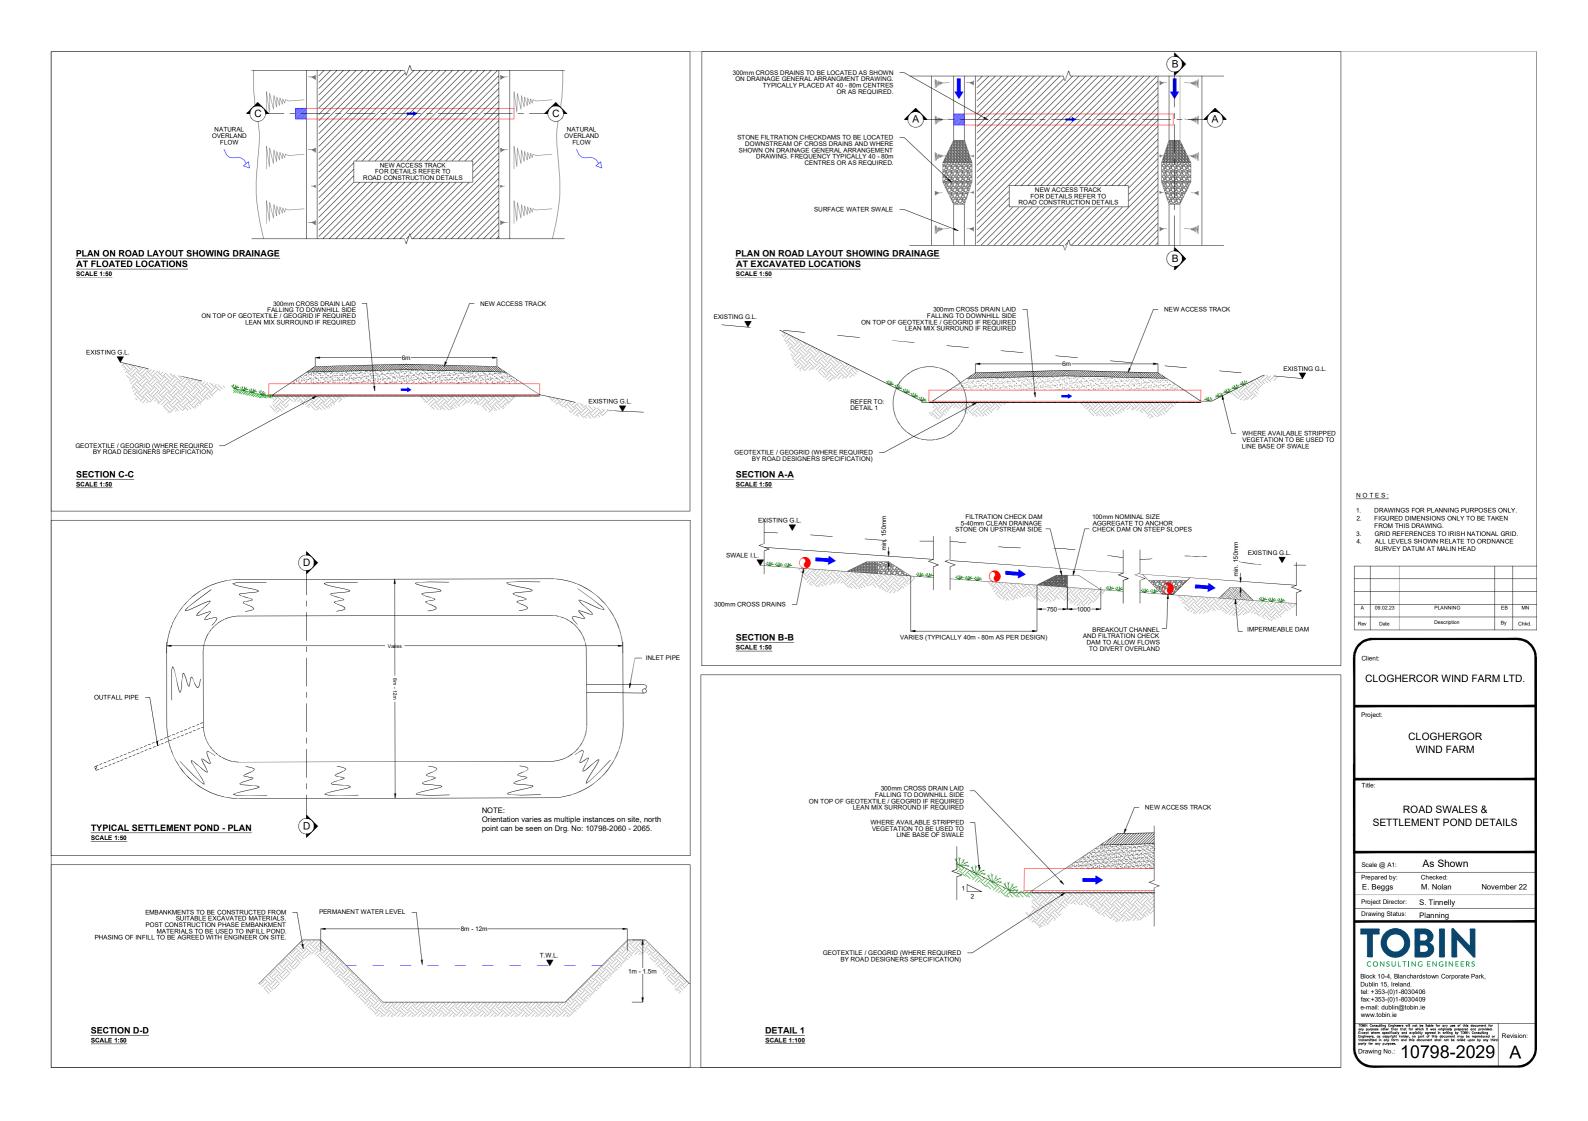

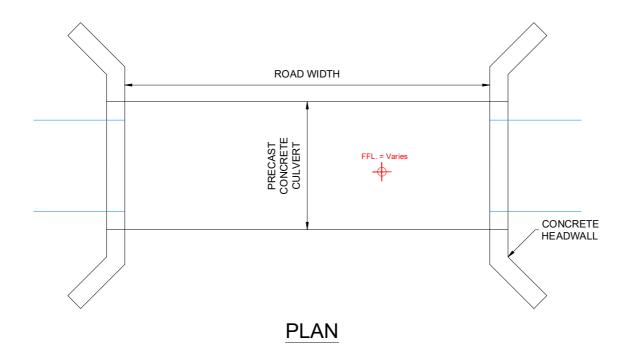

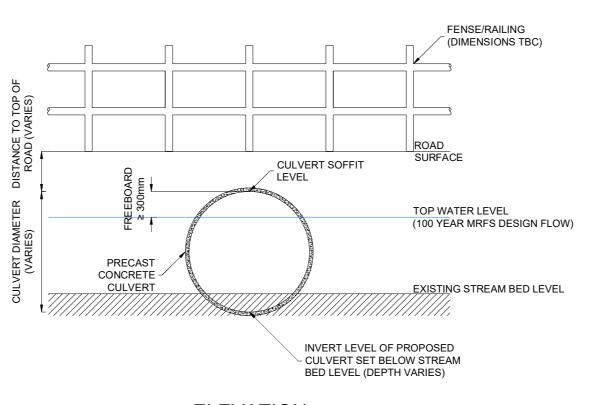

ELEVATION

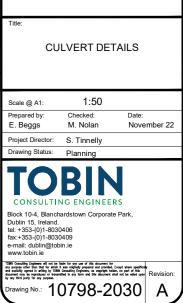

CLOGHERCOR WIND FARM


Project:

CLOGHERCOR WIND FARM LTD.

Client:

A	09.02.23	PLANNING ISSUE	EB	MN
Rev	Date	Description	Ву	Chkd.

NOTE: Orientation varies as multiple instances on site, north point can be seen on Drg. No: 10798-2003.

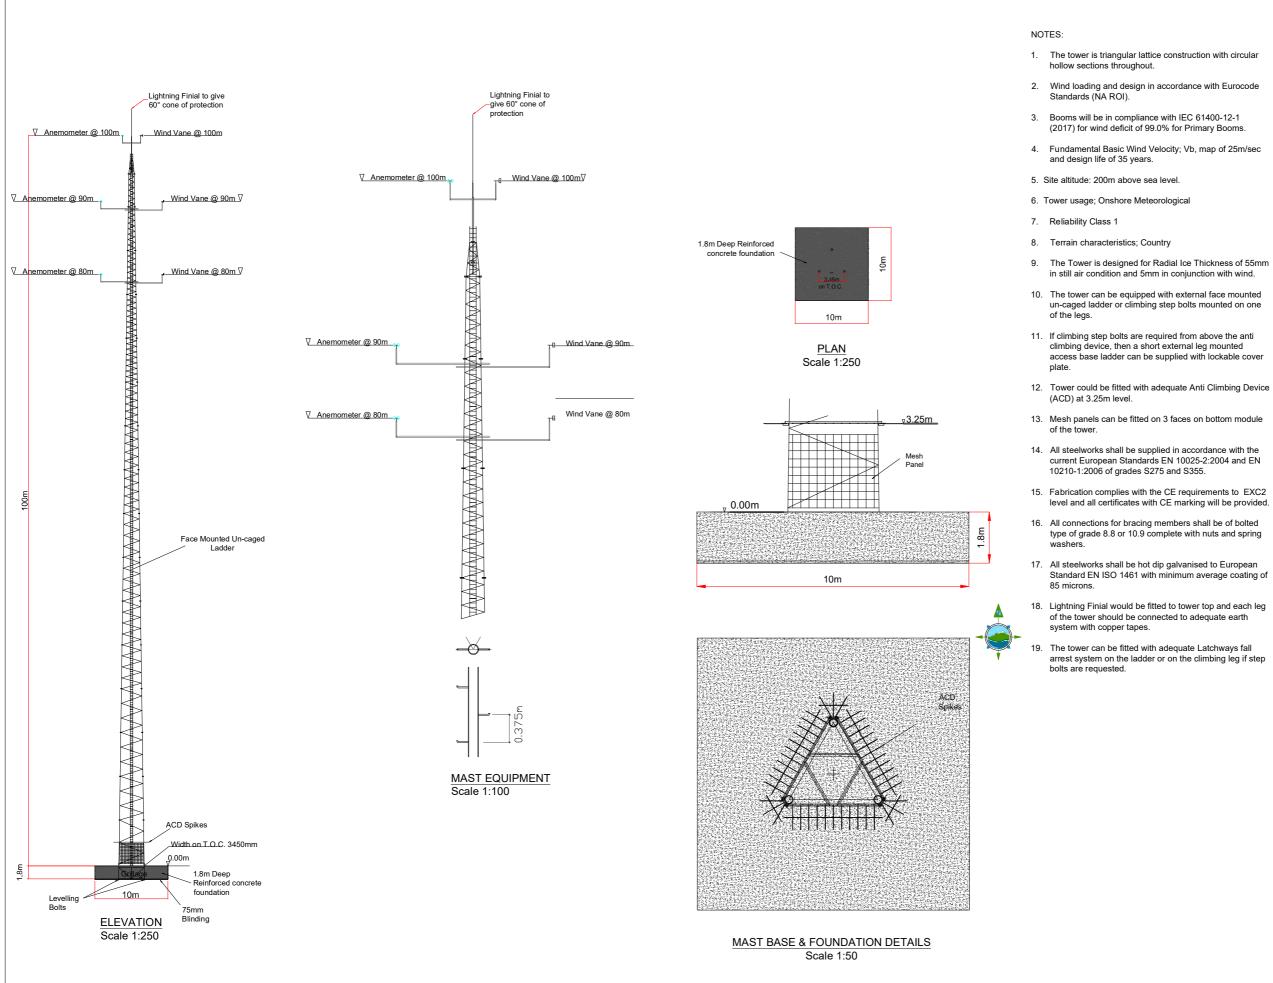

un-caged ladder or climbing step bolts mounted on one

access base ladder can be supplied with lockable cover

level and all certificates with CE marking will be provided.

type of grade 8.8 or 10.9 complete with nuts and spring

Standard EN ISO 1461 with minimum average coating of

arrest system on the ladder or on the climbing leg if step

A	09.02.23	PLANNING ISSUE	EB	MN
Rev	Date	Description	By	Chkd.

CLOGHERCOR WIND FARM LTD.


Project:


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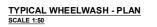
CLOGHERCOR WIND FARM

Title


MET MAST DETAILS




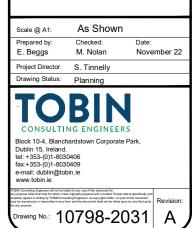

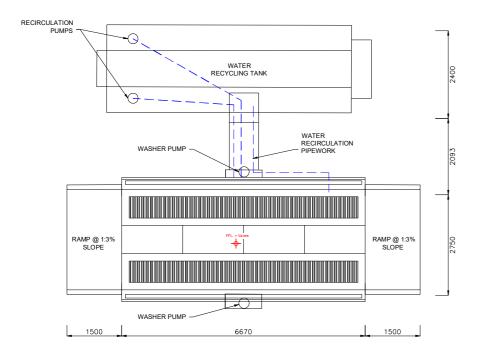

NOTE: Orientation varies as multiple instances on site, north point can be seen on Drg. No: 10798-2003.

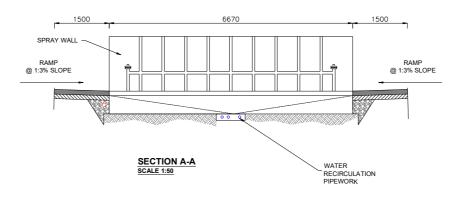

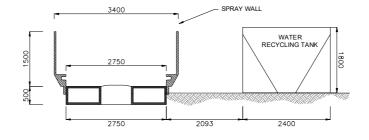

SECTION B-B




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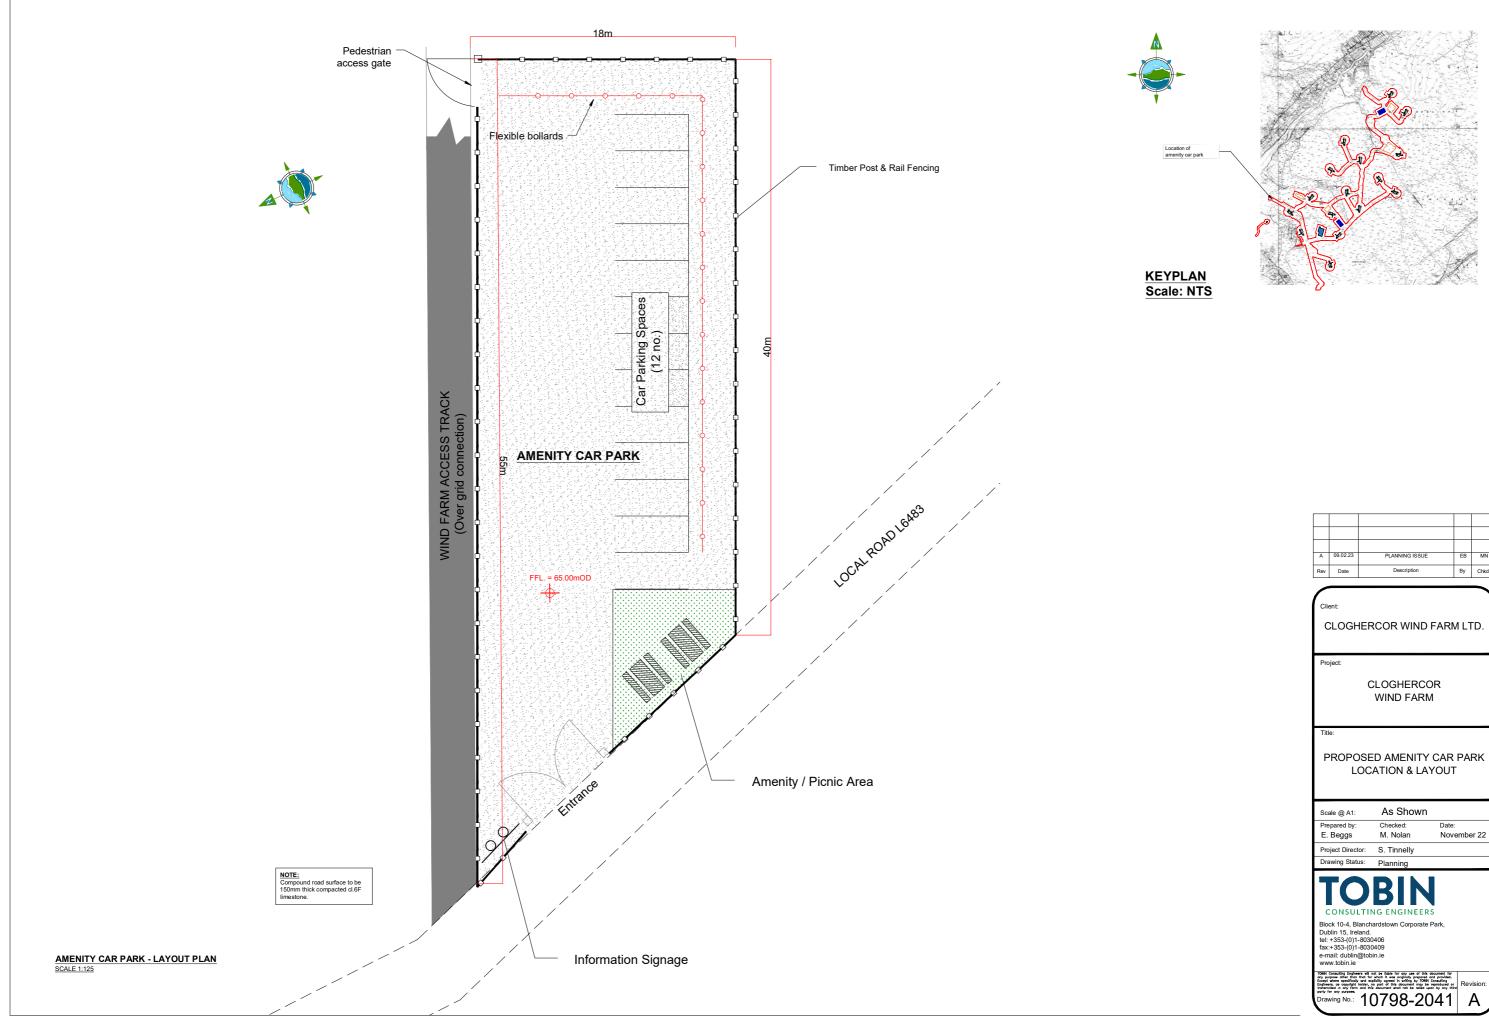
Project:

CLOGHERCOR WIND FARM LTD.

Client:


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Rev	Date	Description	Ву	Chkd.



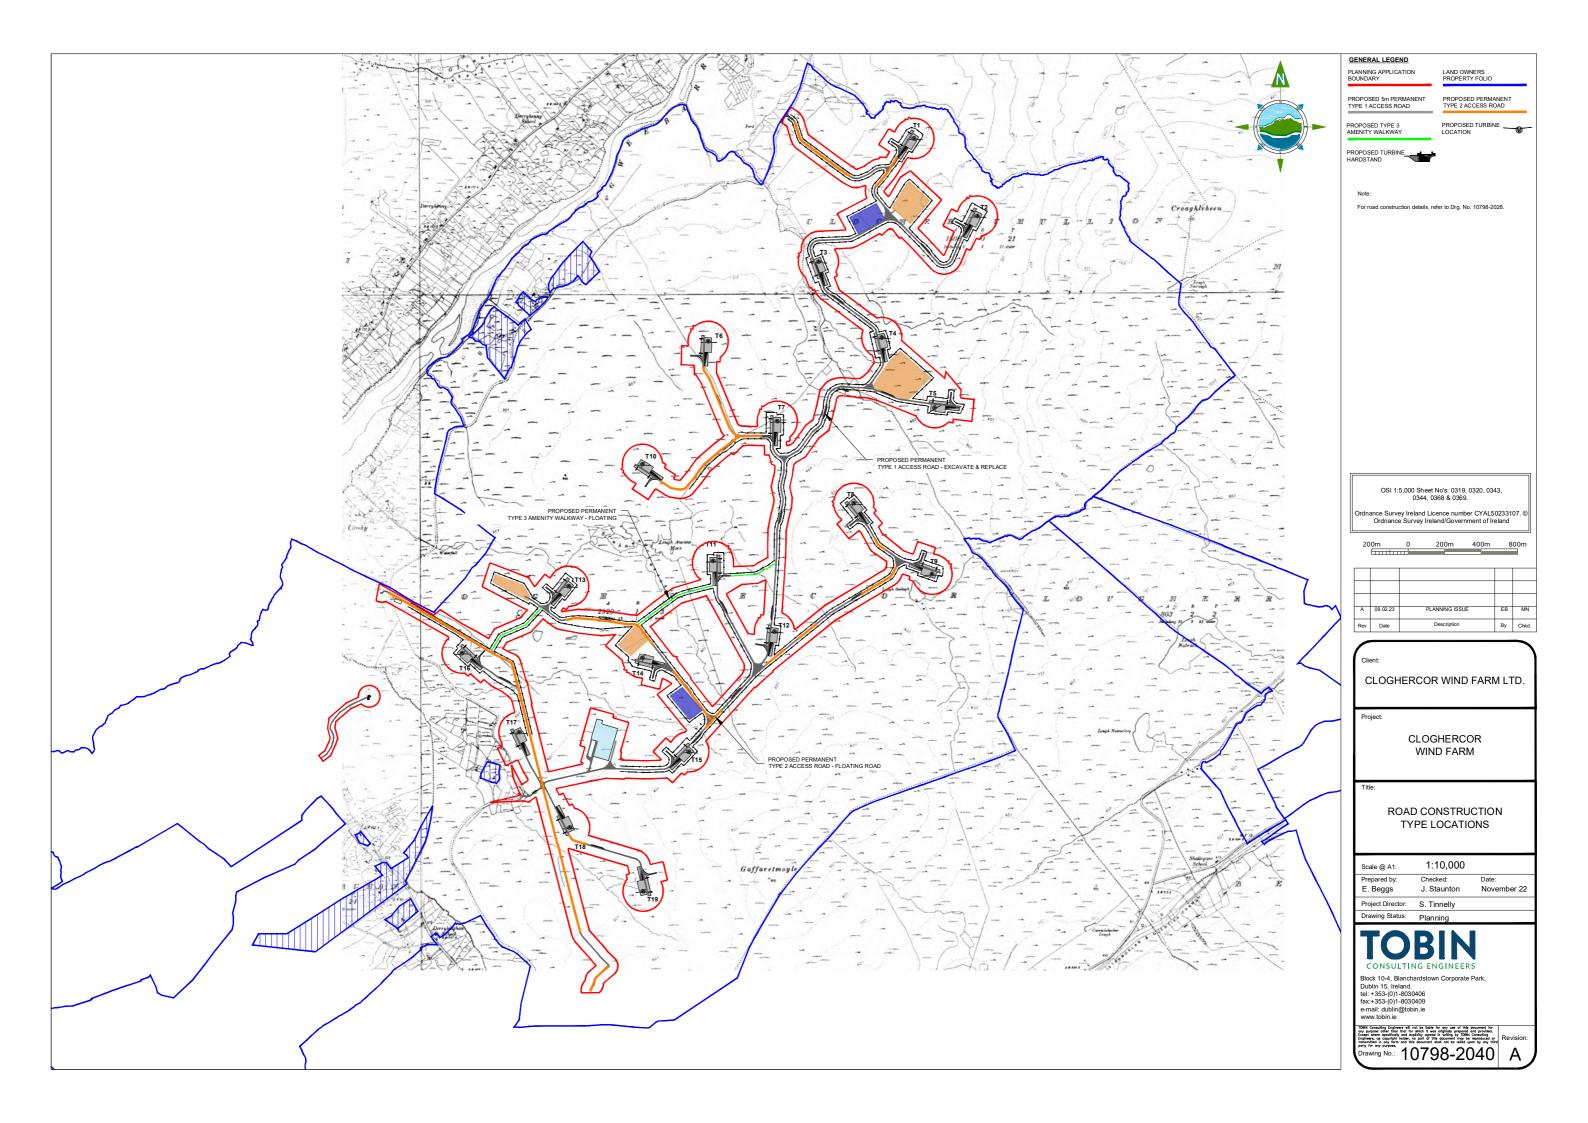

A	09.02.23	PLANNING ISSUE	EB	MN
Rev	Date	Description	Ву	Chkd.

Scale @ A1:	As Shown	
Prepared by: E. Beggs	Checked: M. Nolan	Date: November 22
Project Director:	S. Tinnelly	
Drawing Status:	Planning	

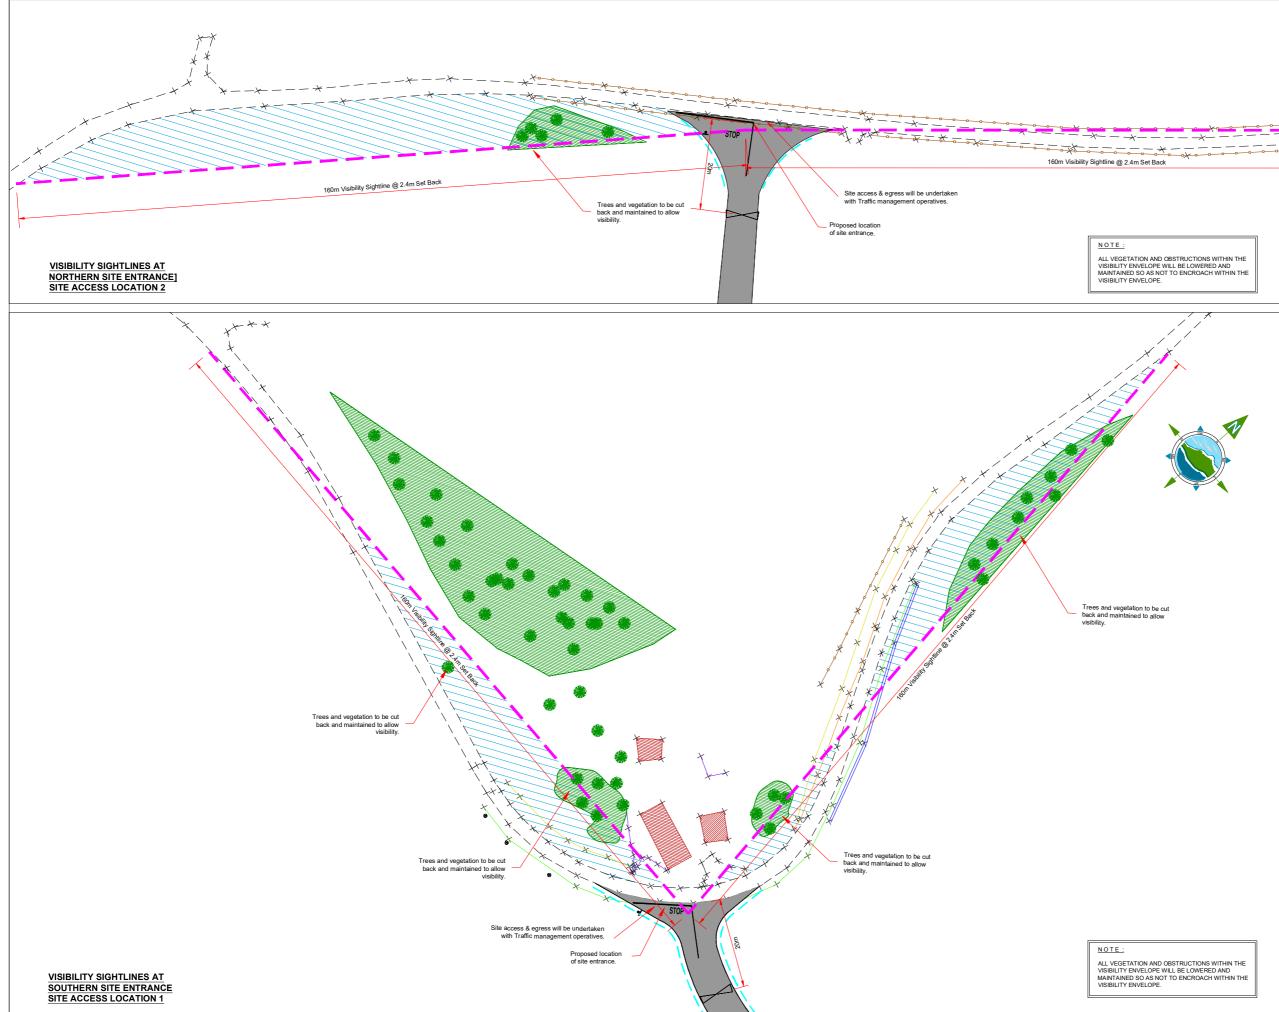



Plan Legend: Visibility Sightline Visibility Envelope Scrub / Vegetation Area Existing Road Edge Existing Drain Proposed Filter Drain Top of Bank Bottom of Bank Grass Edge Verge Existing Wall Existing Building Existing Fenceline Existing Tree / Bush

A 09.02.23 PLANNING ISSUE FB Description By Chkd. Rev Date

Client:

CLOGHERCOR WIND FARM LTD.

Project:

CLOGHERCOR WIND FARM

Title


VEHICULAR TRAFFIC ENTRANCE DETAILS & VISIBILITY SIGHTLINES

1:400 Scale @ A1: Prepared by: Date: Checked M. Nolan November 22 E. Beggs Project Director: S. Tinnelly

Drawing Status: Plannin BIN

CONSULTING ENGINEERS Block 10-4, Blanchardstown Corporate Park Dublin 15, Ireland. tel: +353-(0)1-8030406 fax:+353-(0)1-8030409 e-mail: dublin@tobin.ie www.tobin.ie

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Plan Legend:

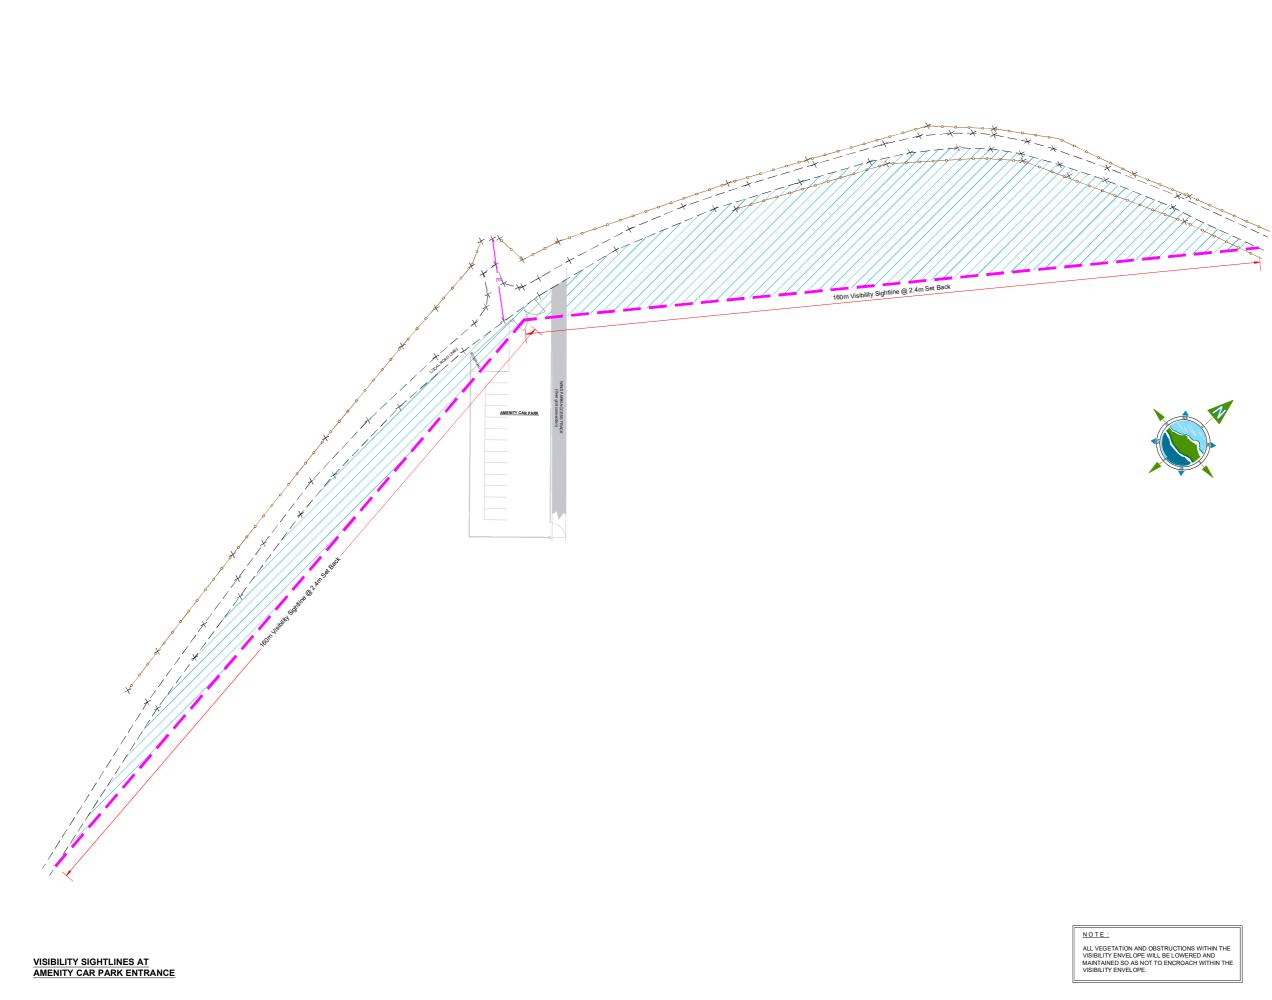Visibility Sightline Visibility Envelope Existing Road Edge Existing Drain Grass Edge Verge Existing Fenceline Existing Tree / Bush





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CLOGHERCOR WIND FARM LTD.

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CLOGHERCOR WIND FARM


AMENITY CAR PARK ENTRANCE VISIBILITY SIGHTLINES


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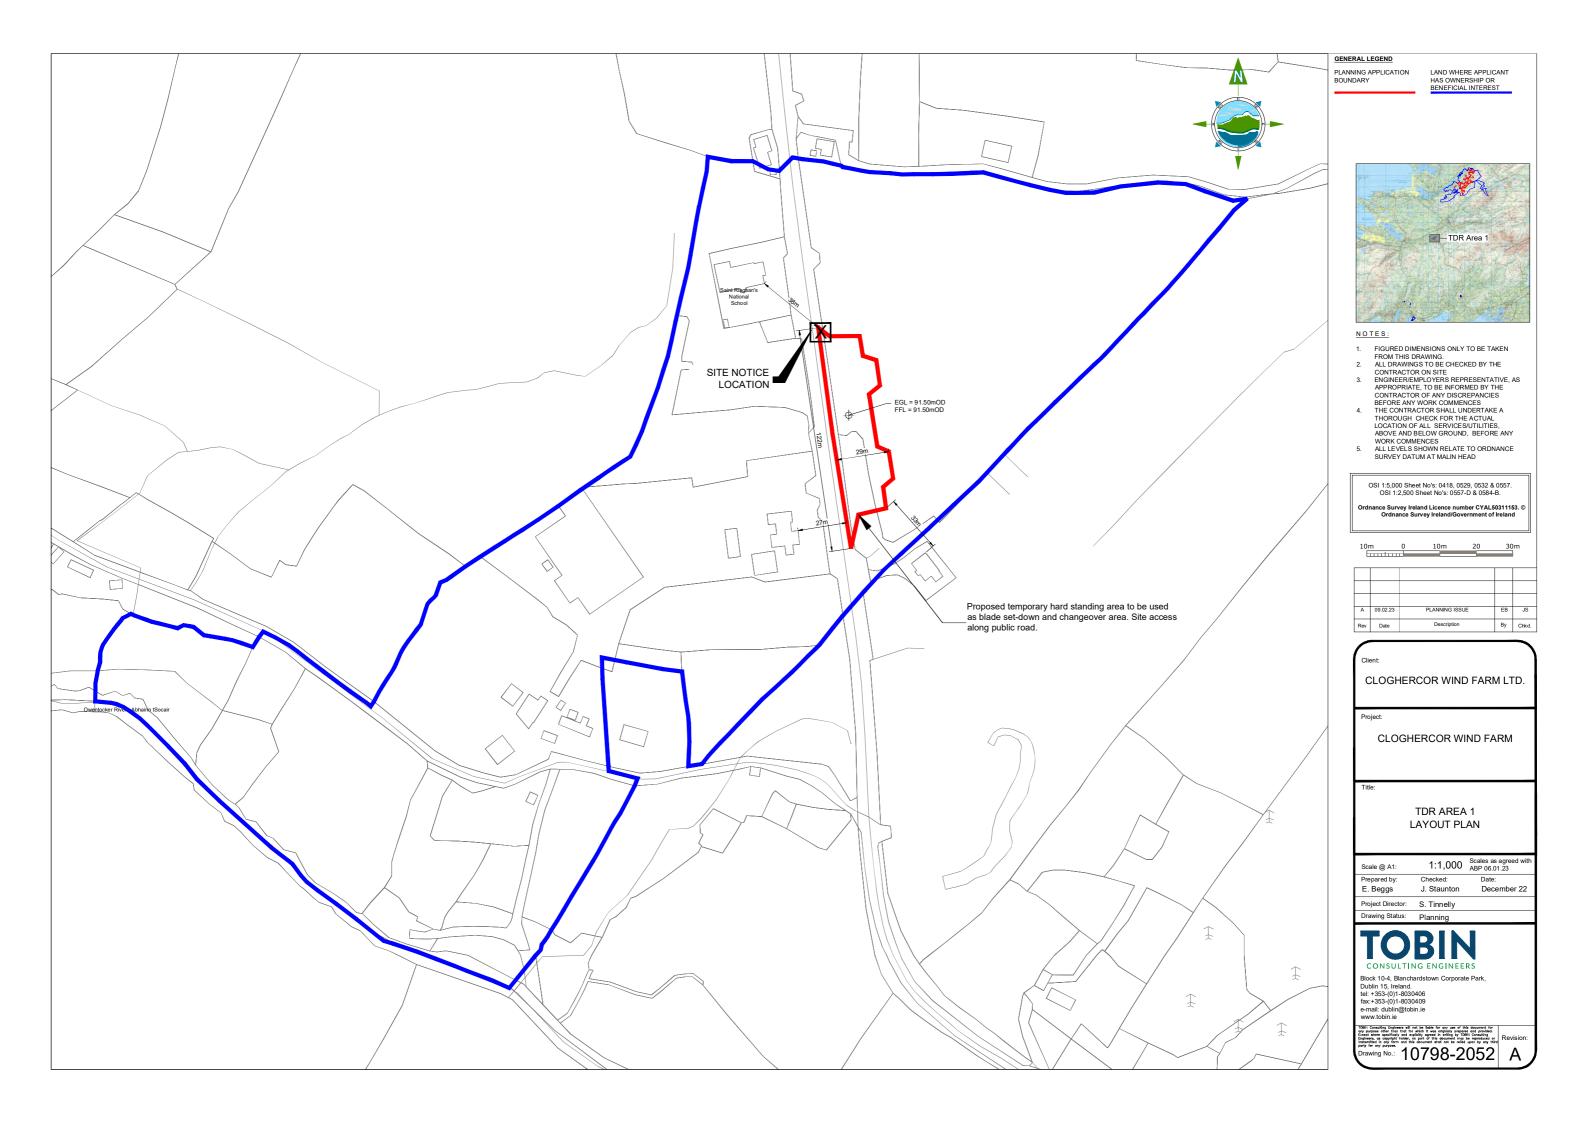
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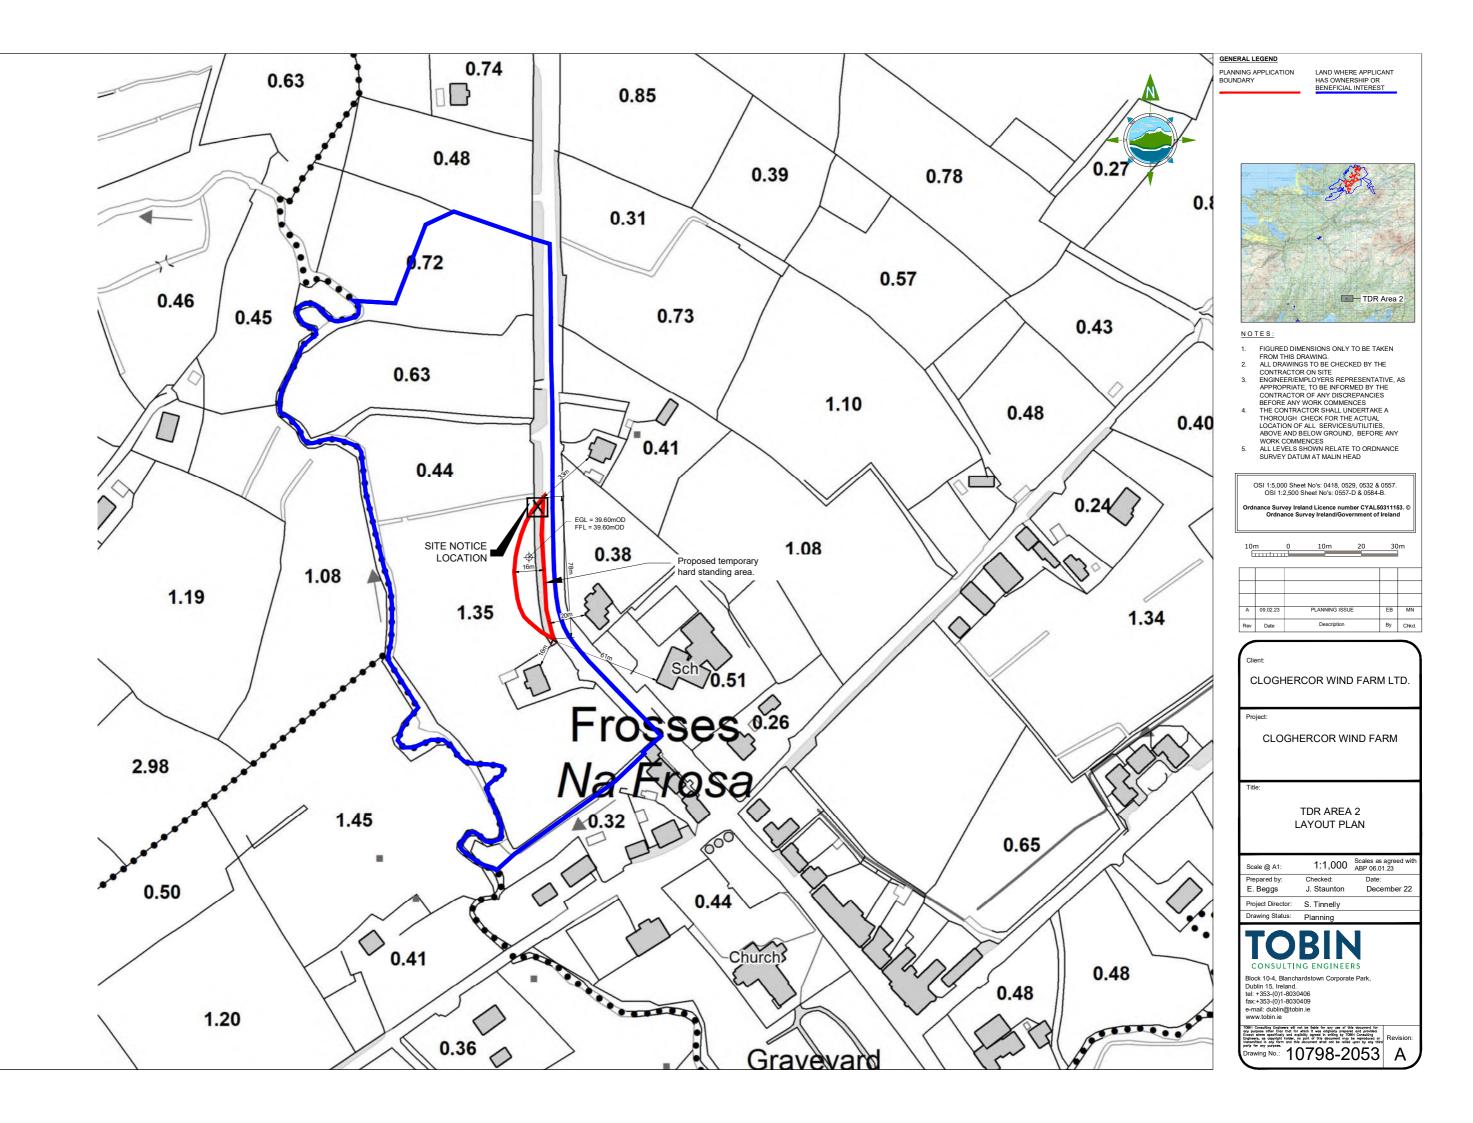



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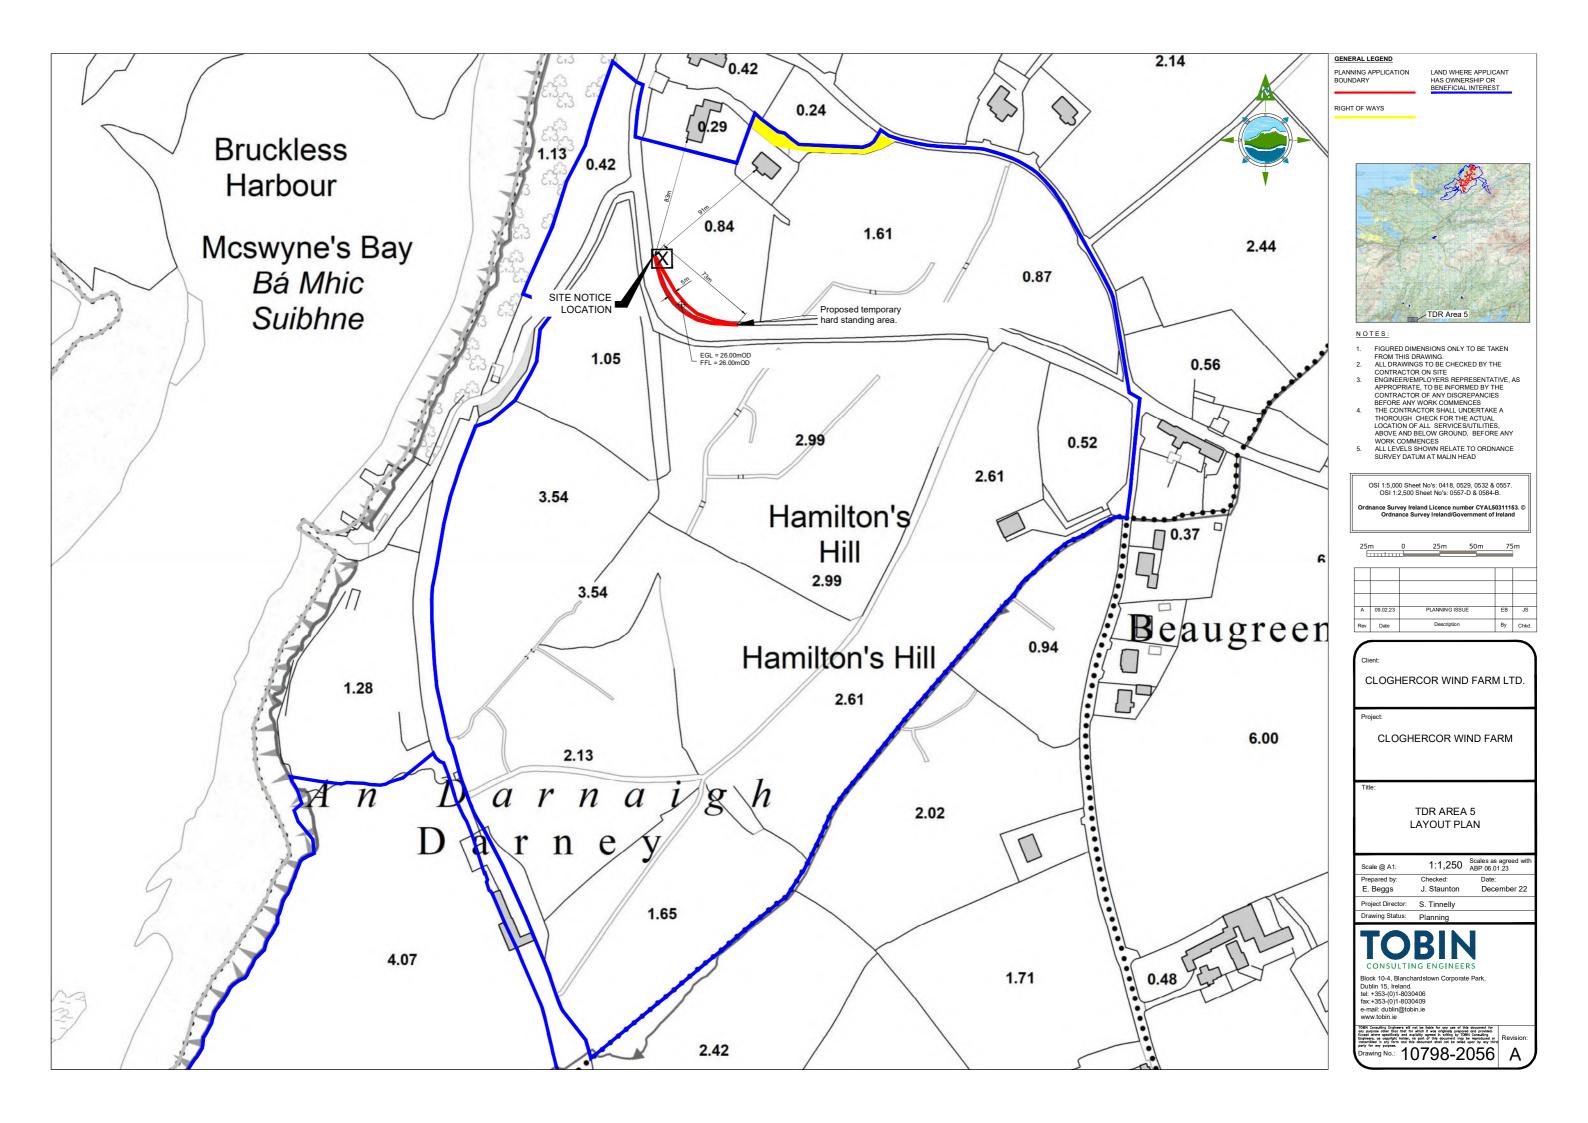








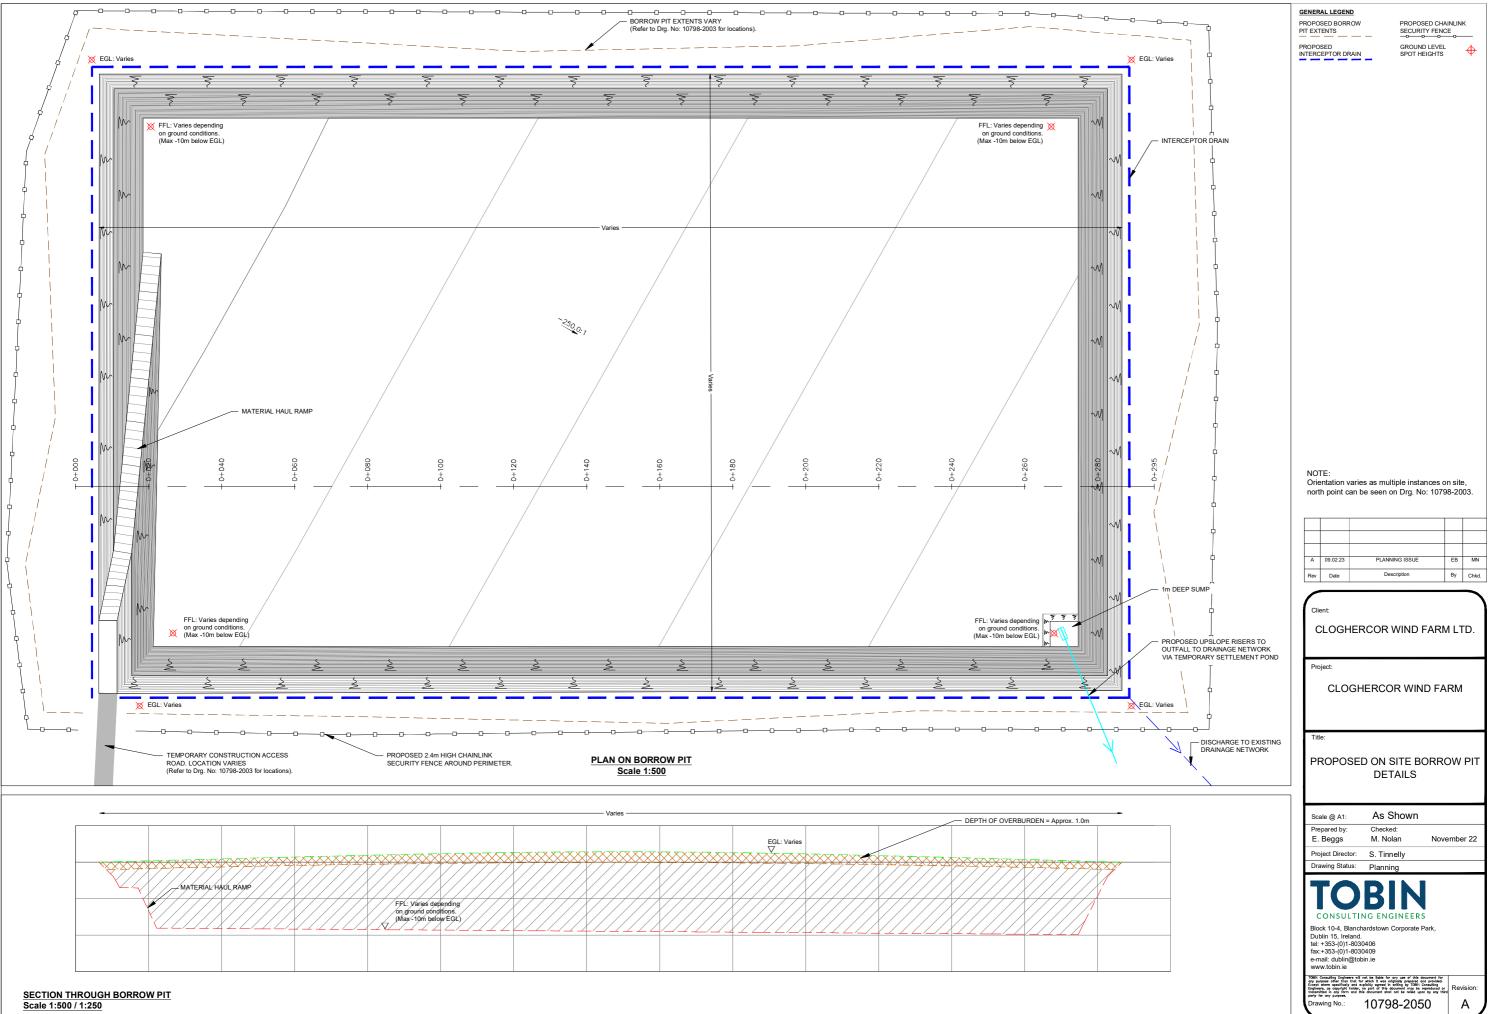

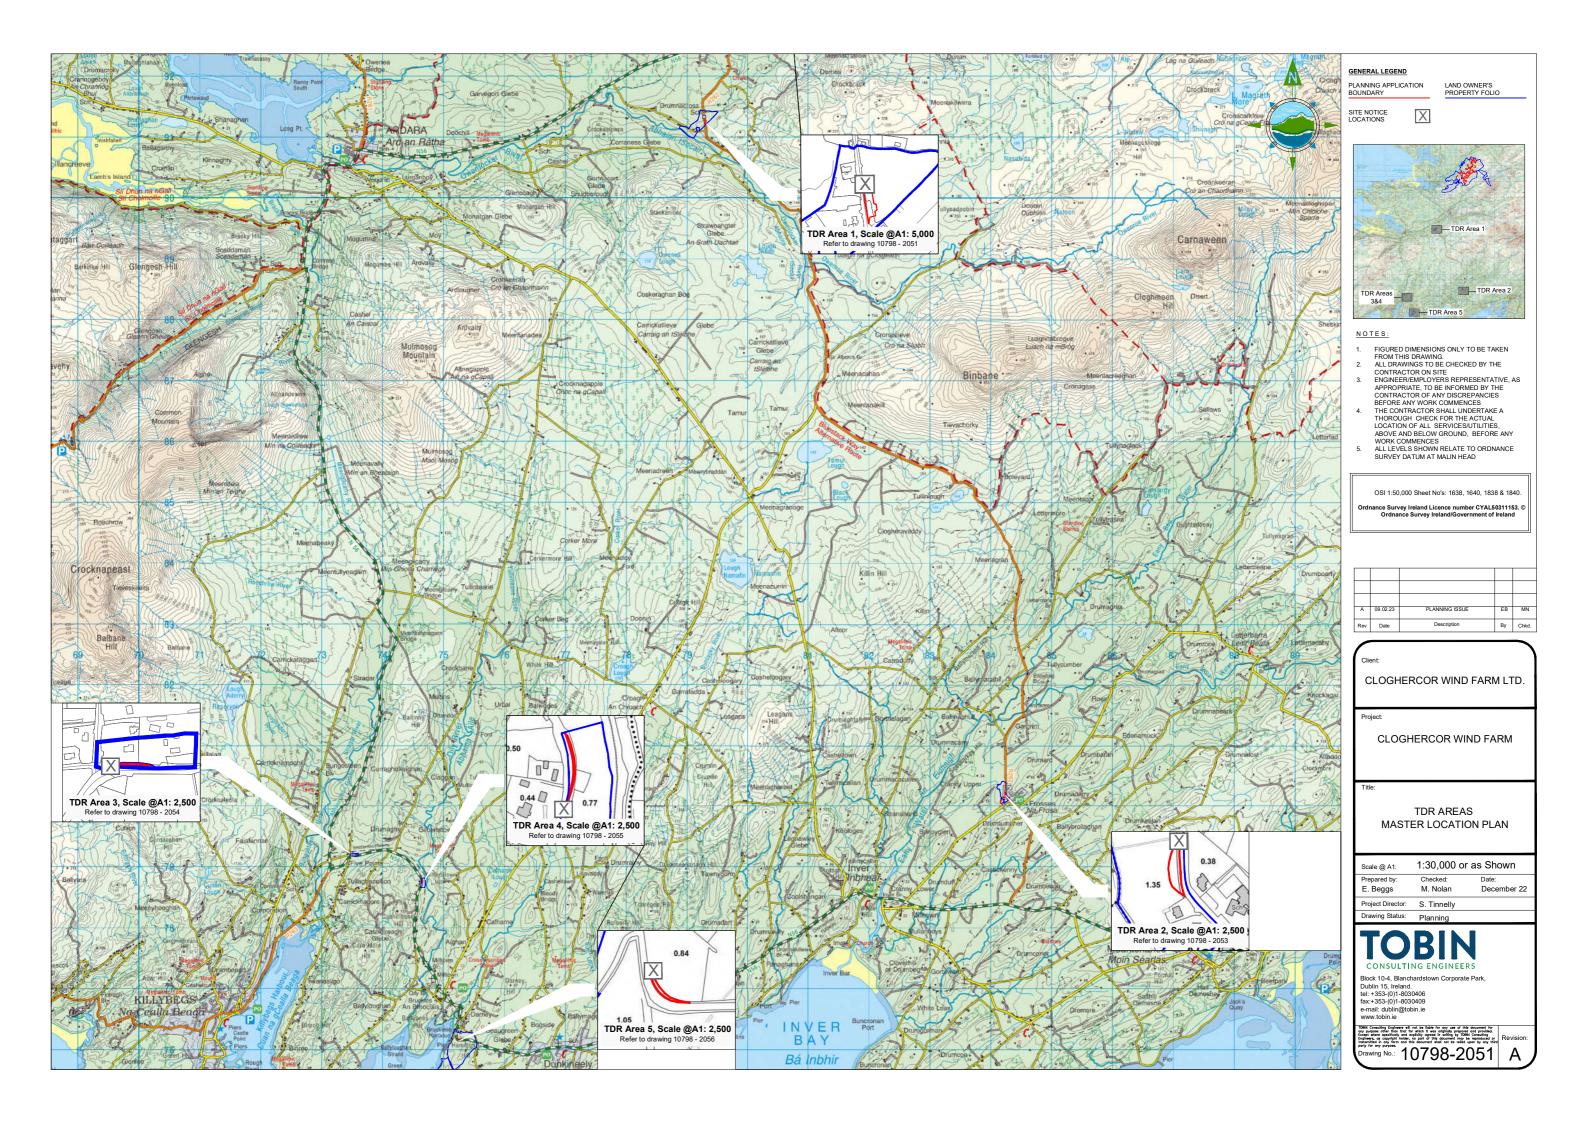


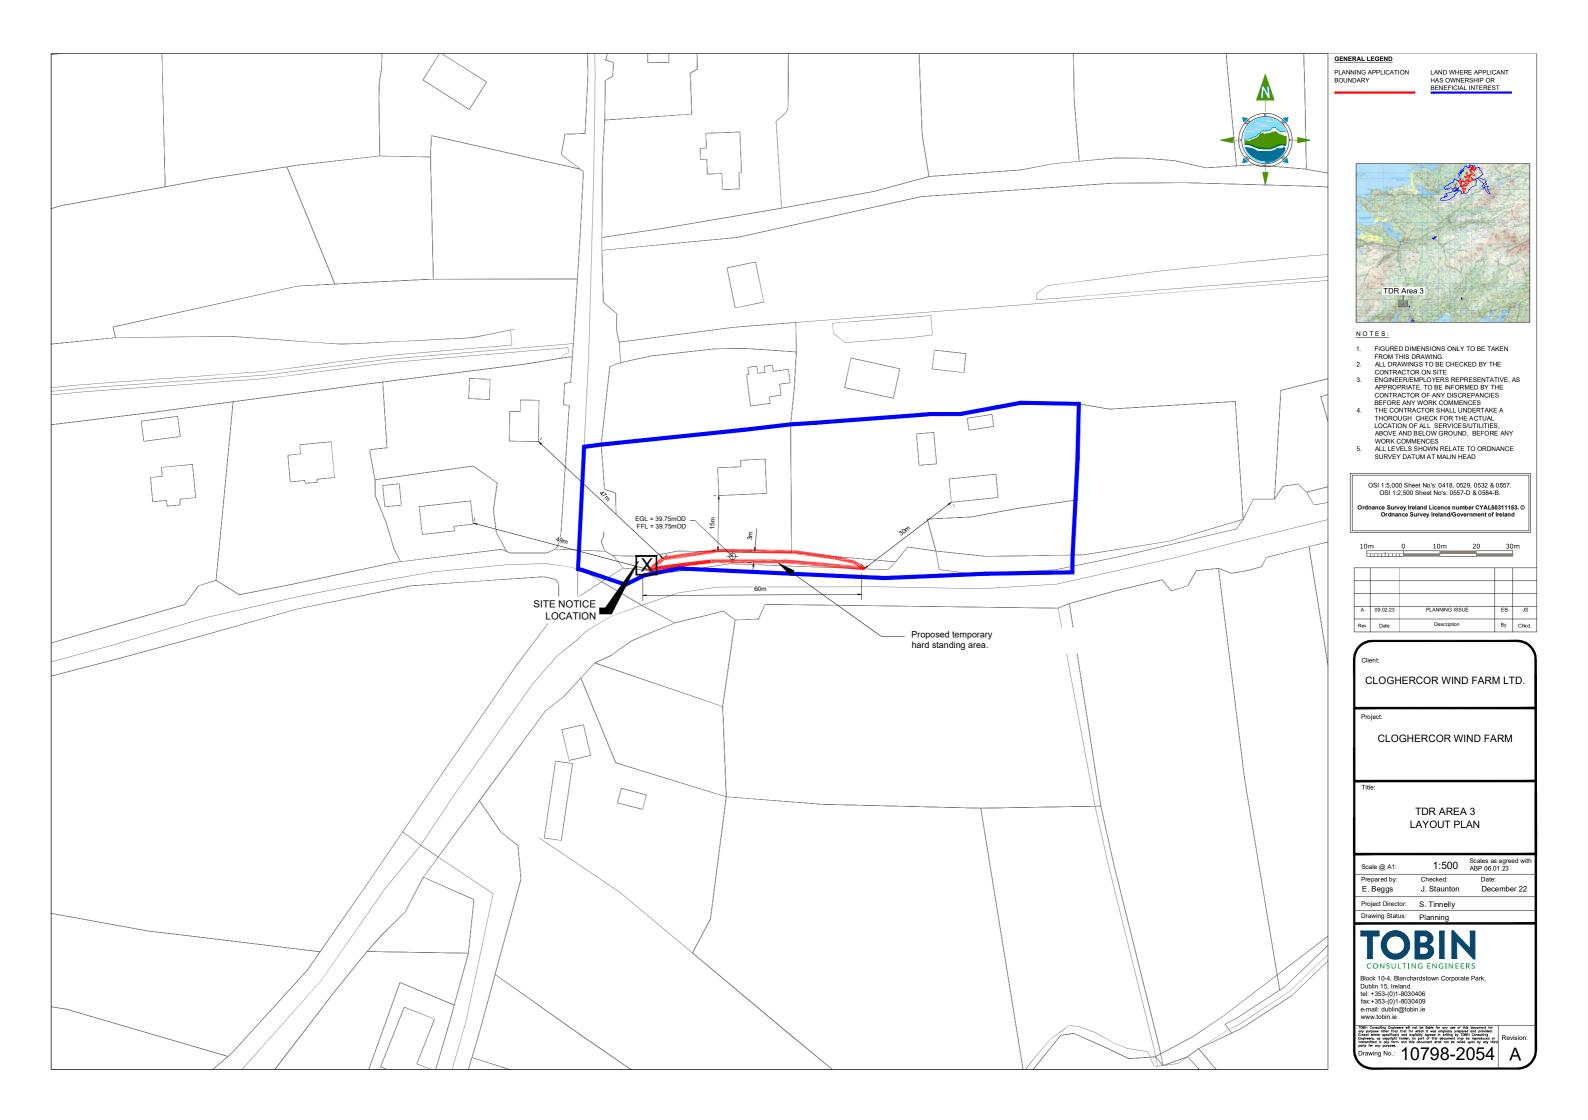


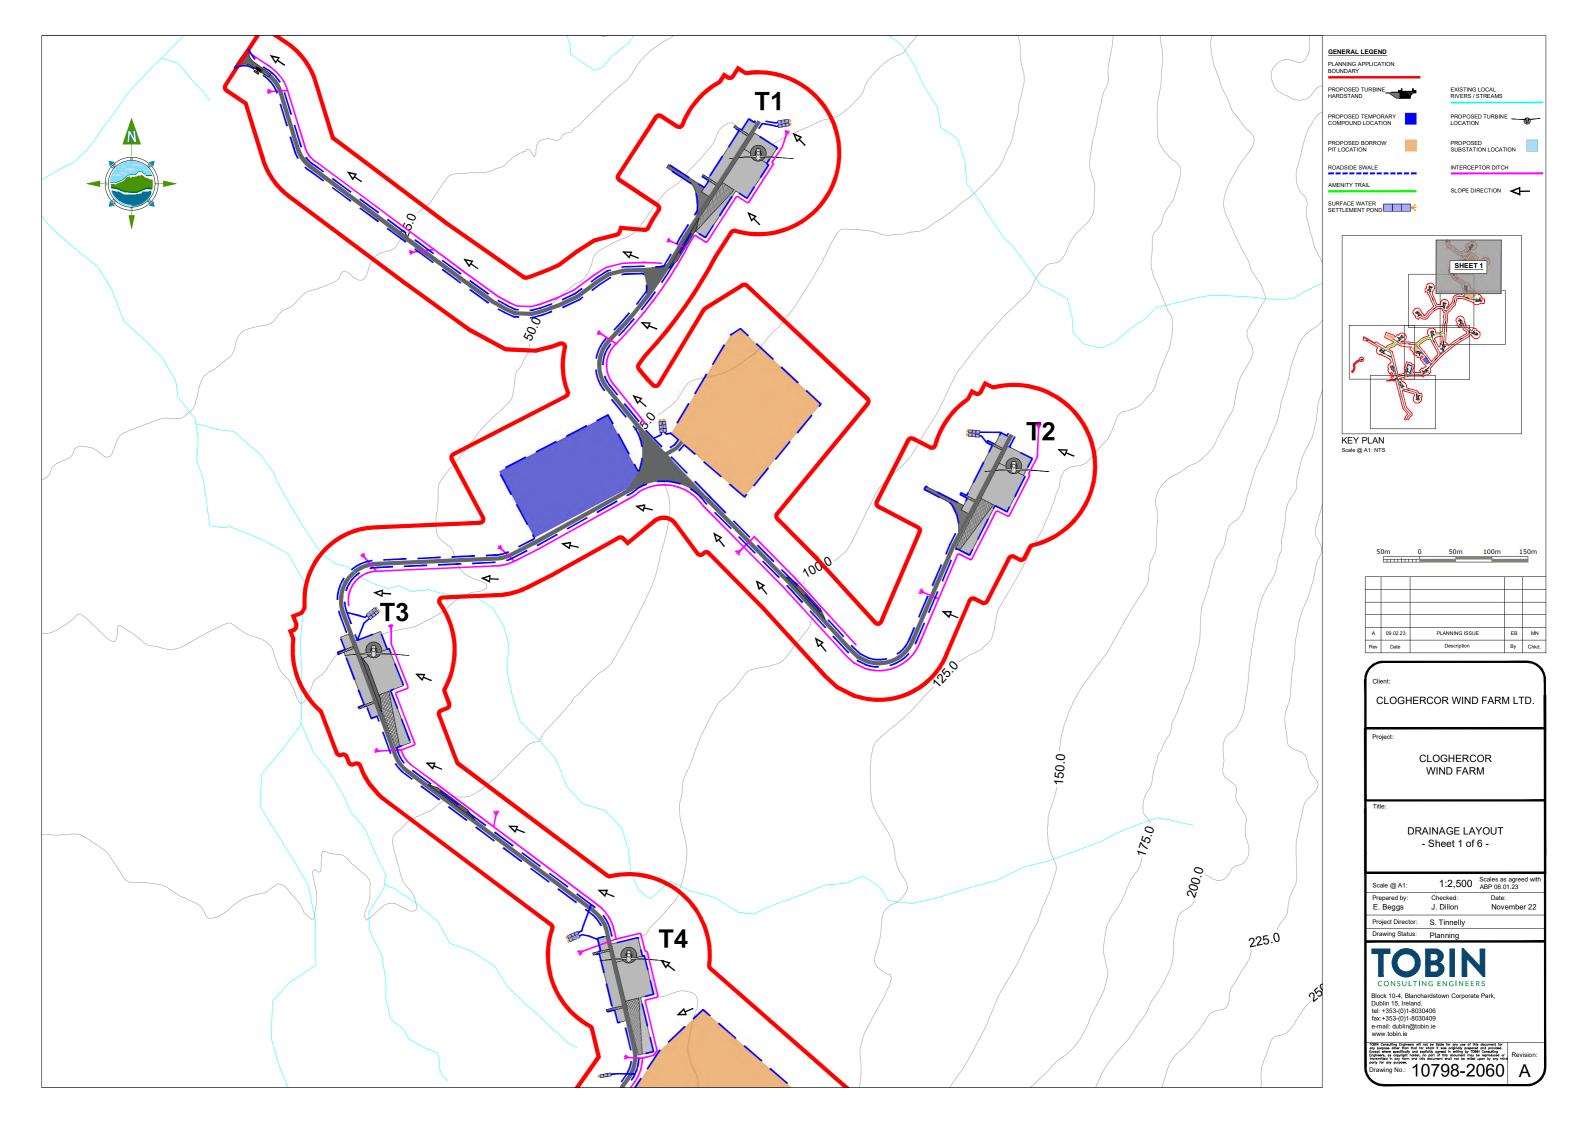


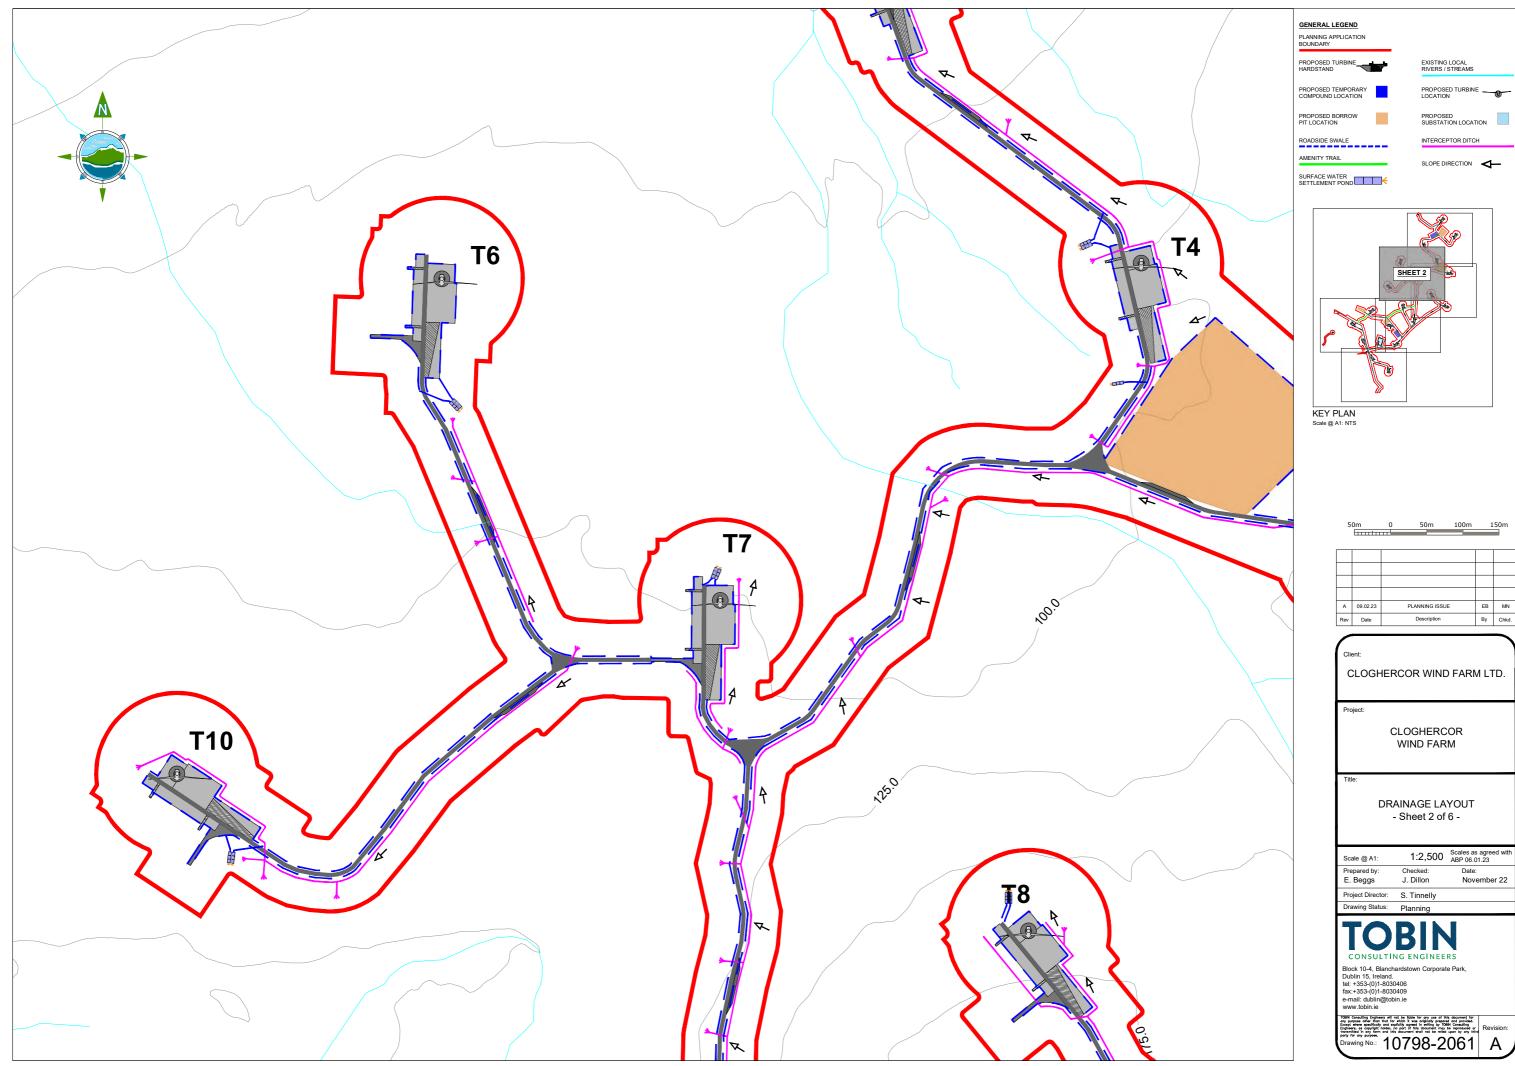



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Rev	Date	Description	By	Chkd.
Client: CLOGHERCOR WIND FARM LTD.				
Project: CLOGHERCOR WIND FARM				
Title: DRAINAGE LAYOUT - Sheet 2 of 6 -				
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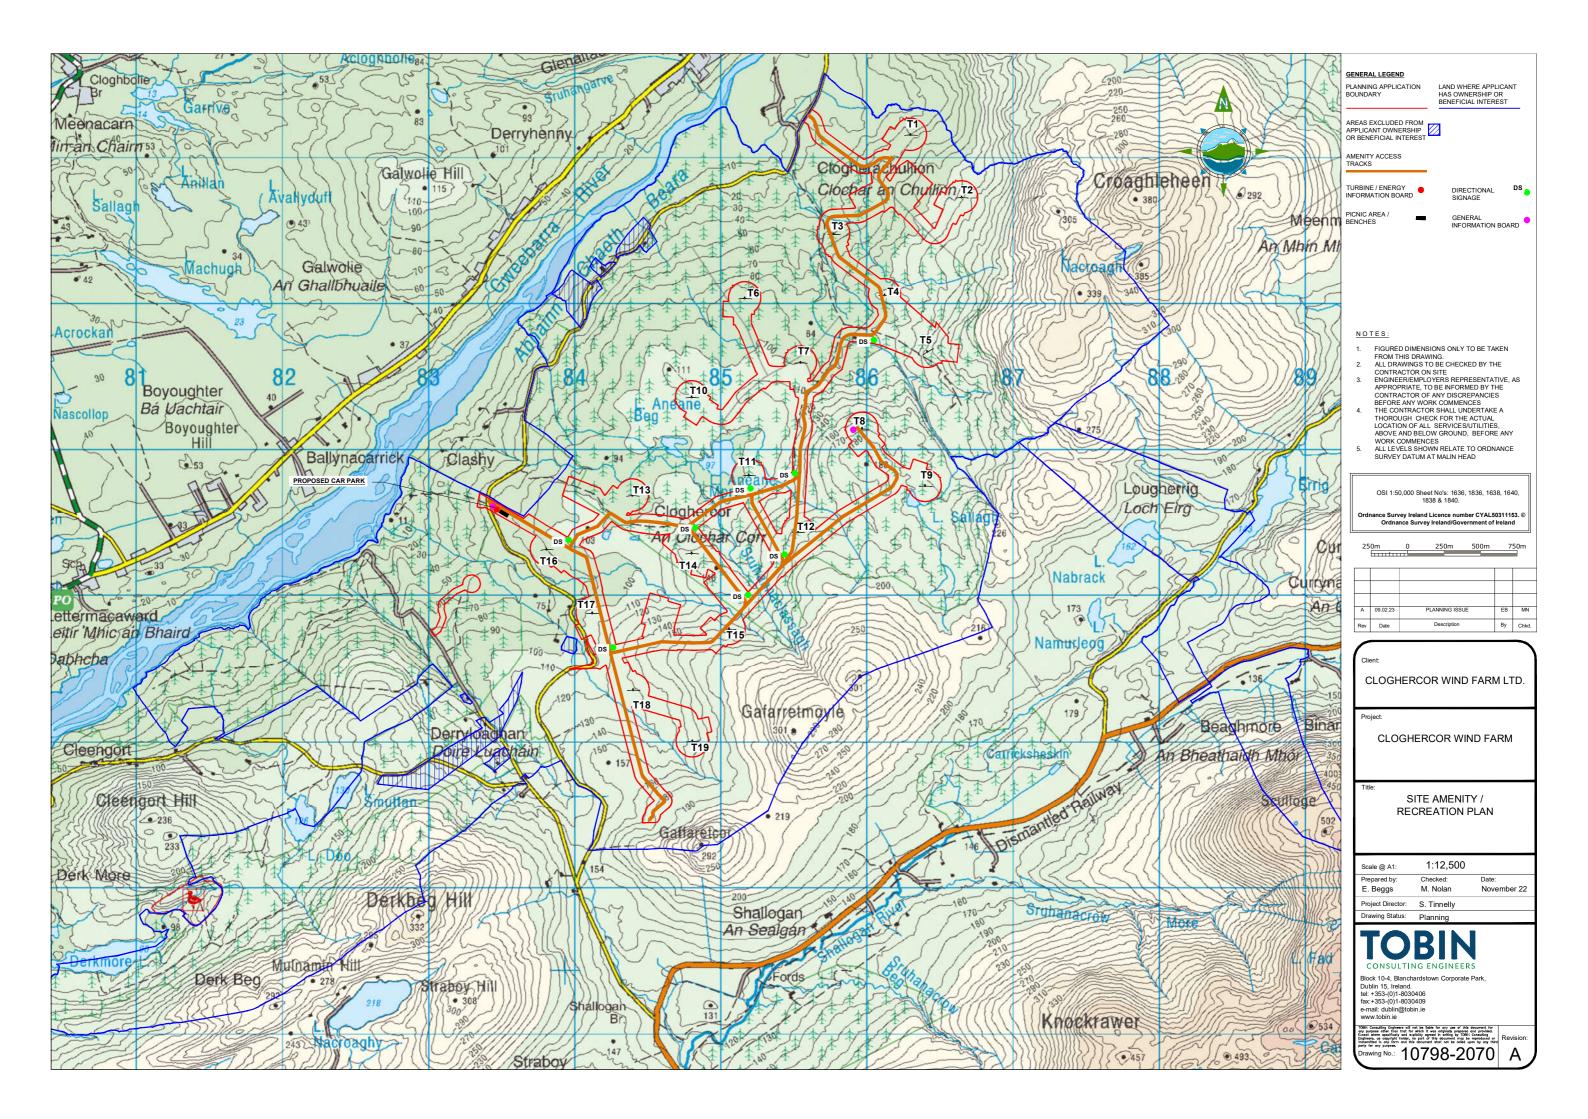


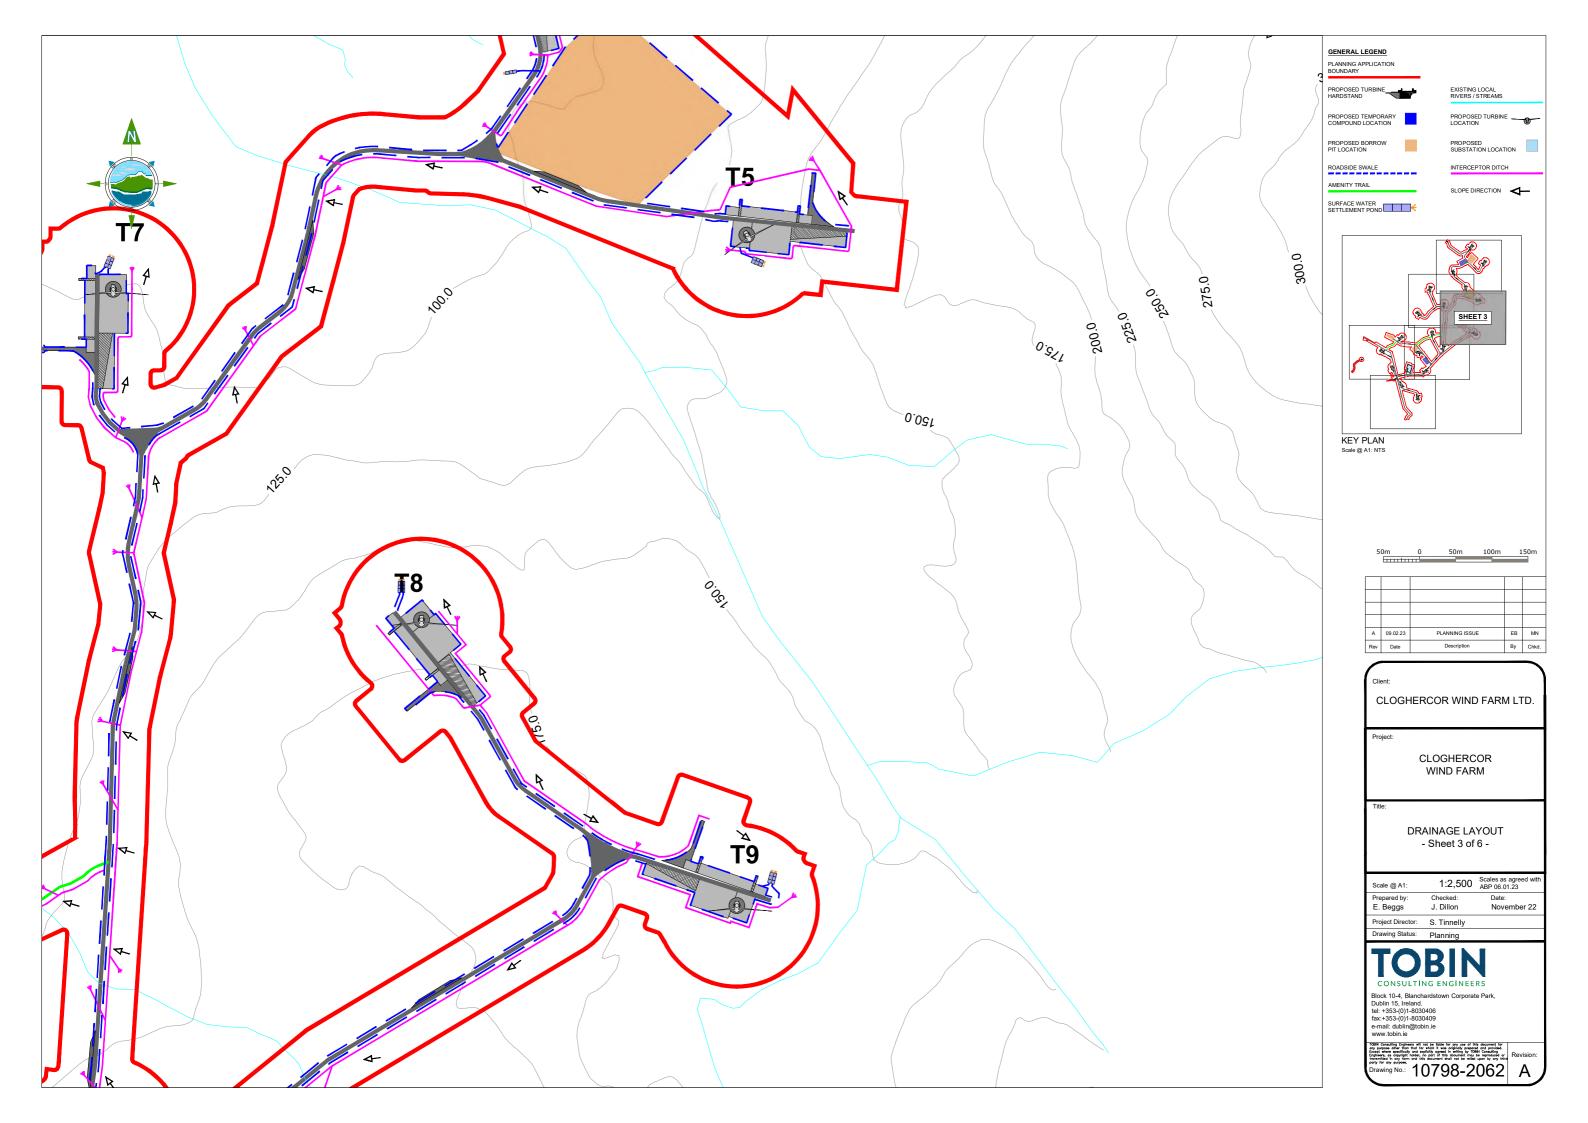


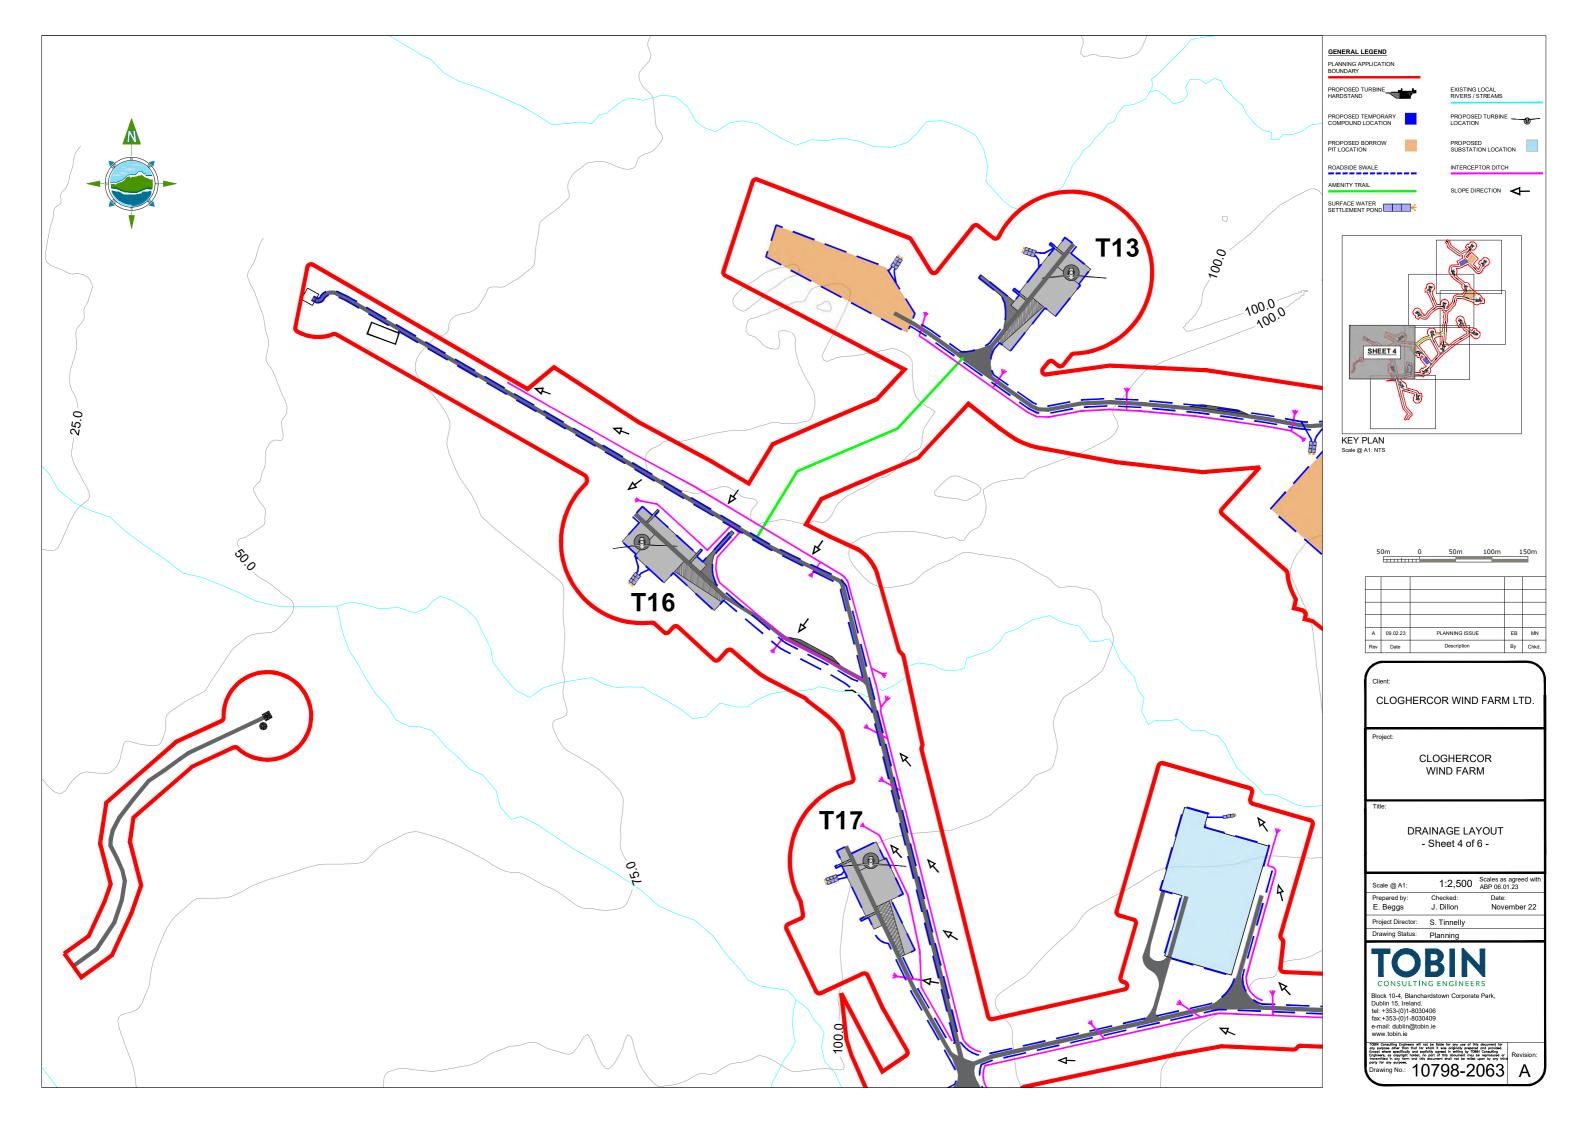


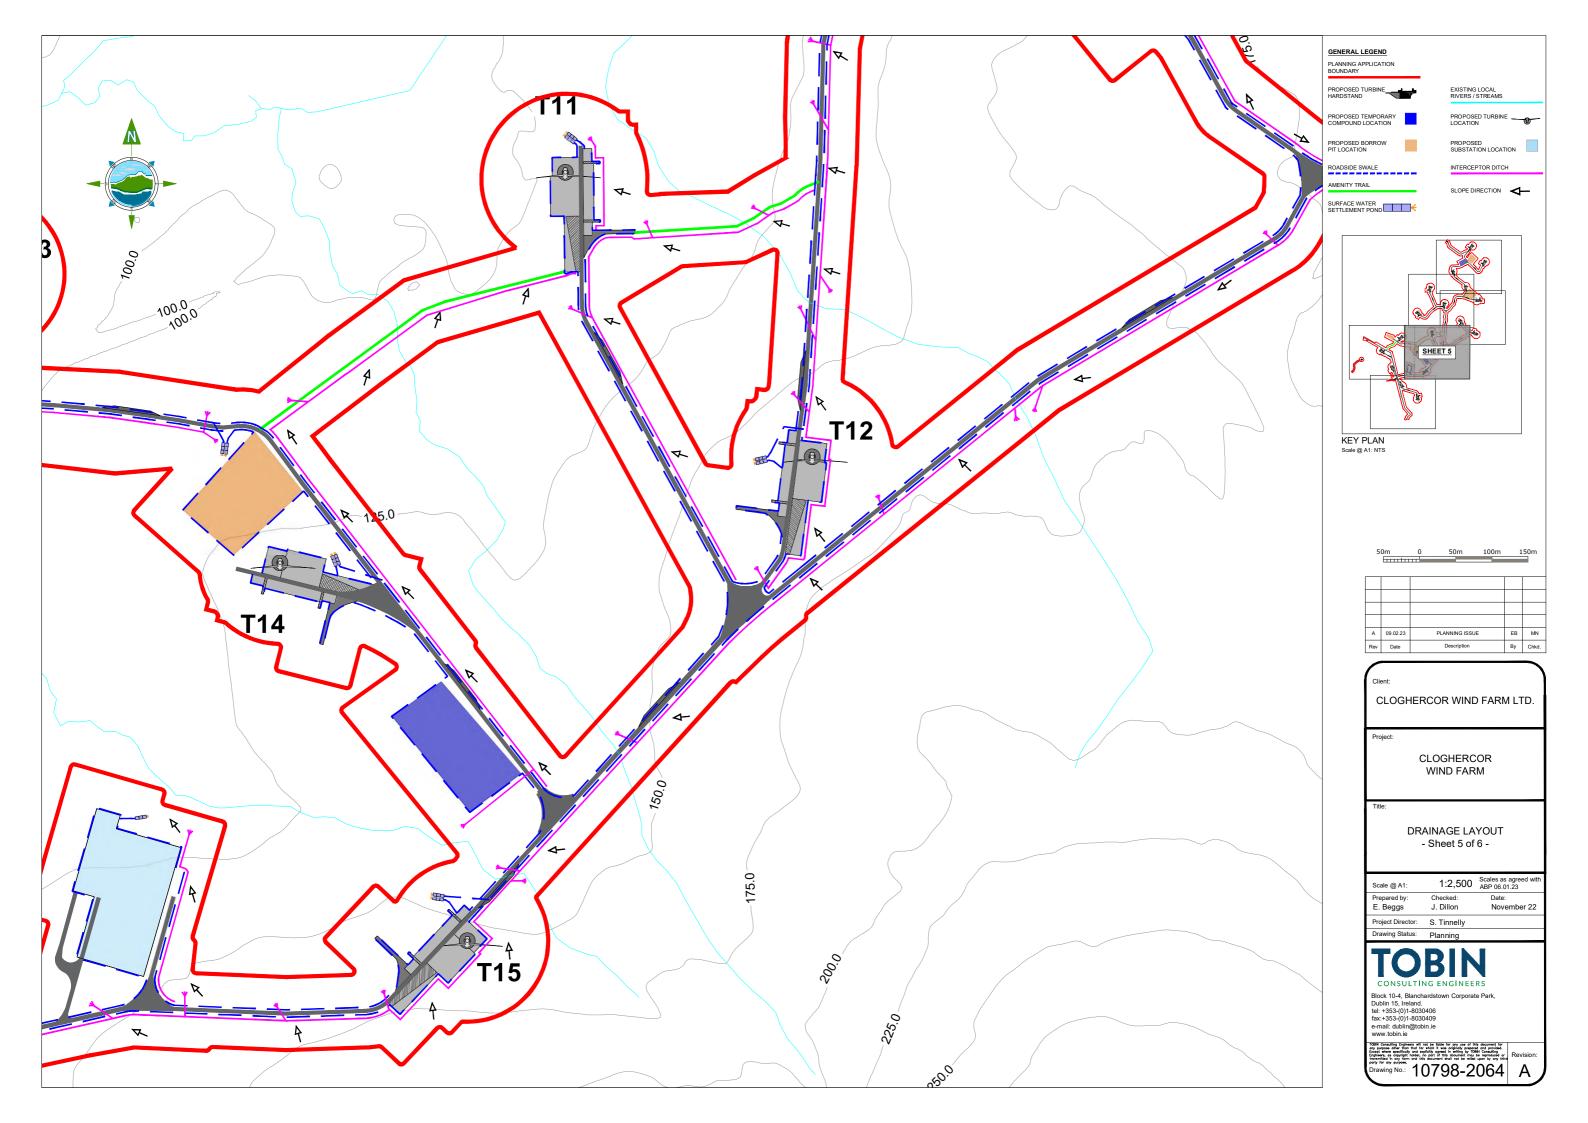

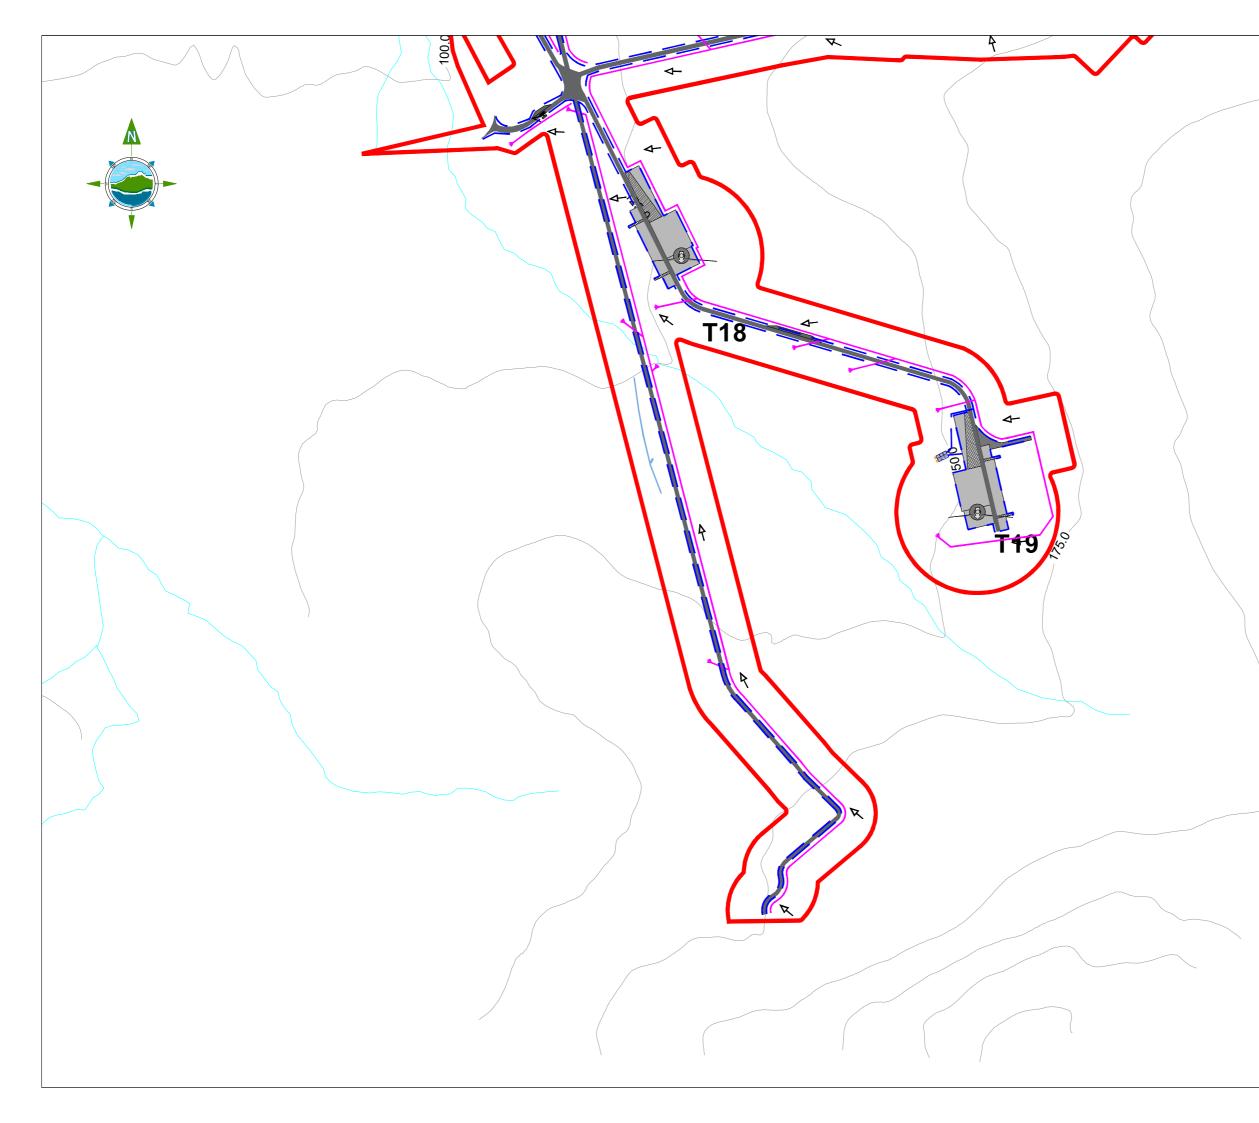

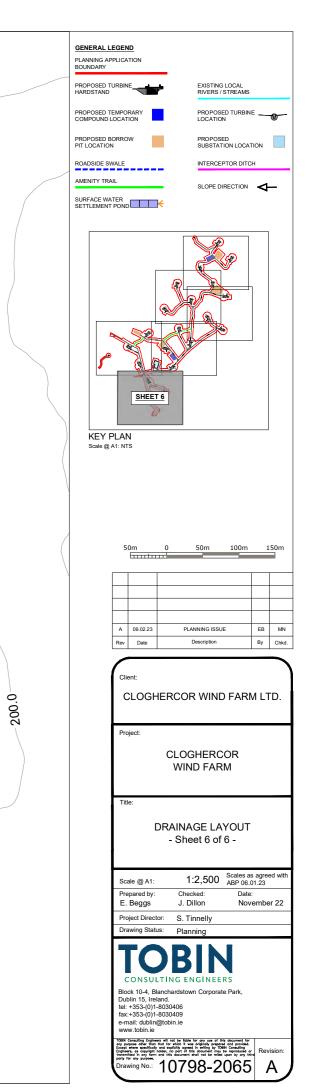

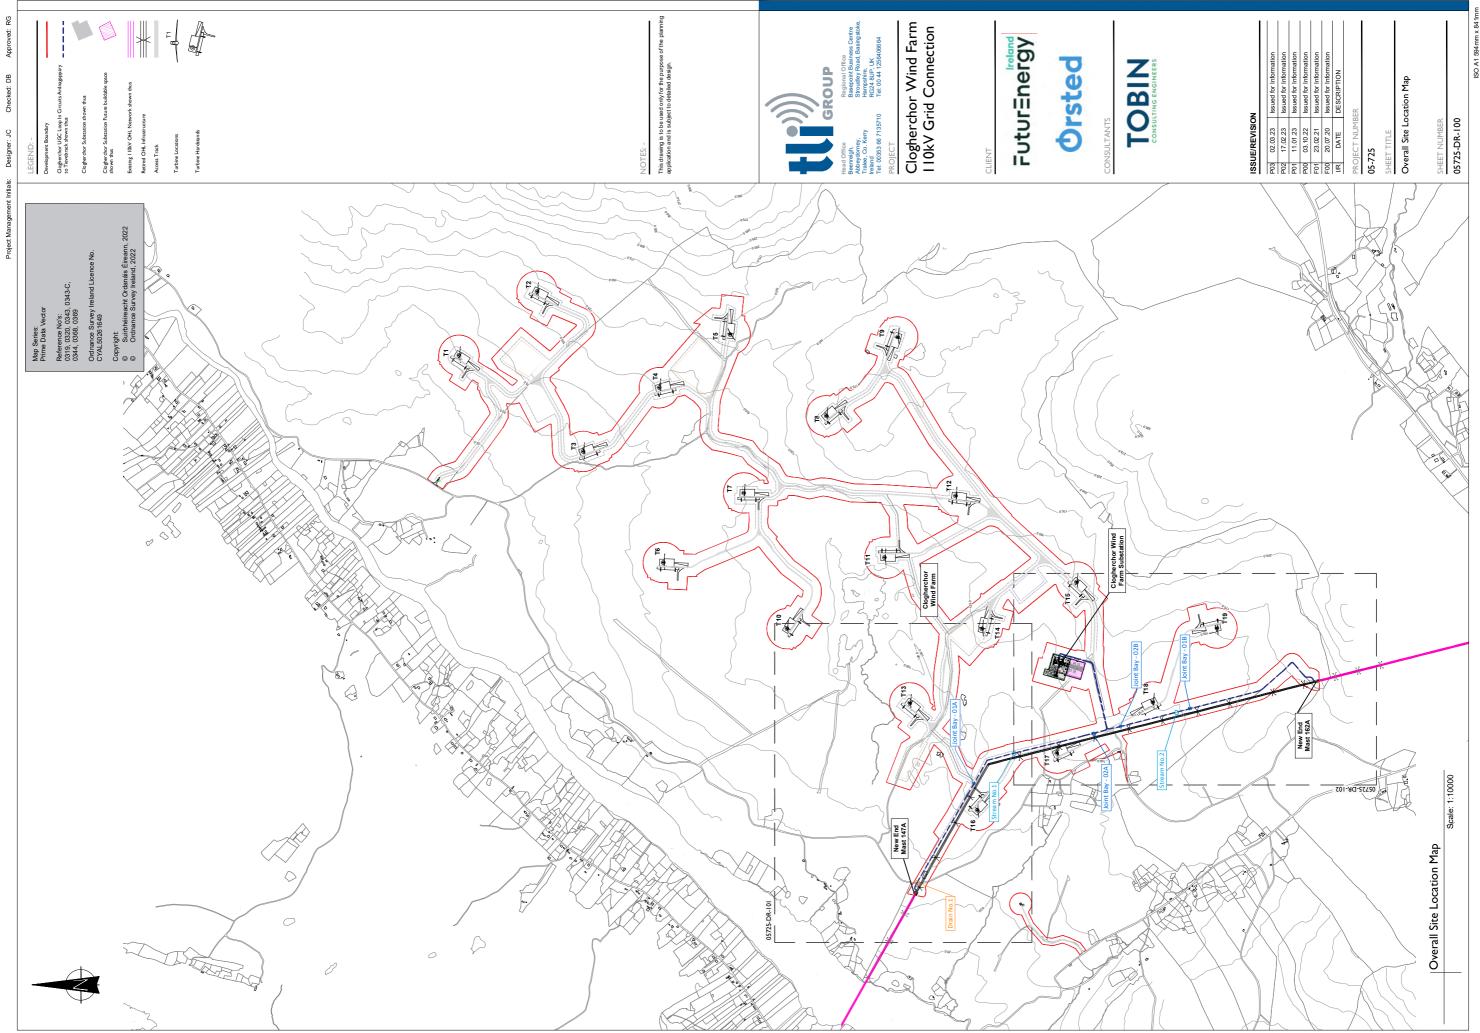

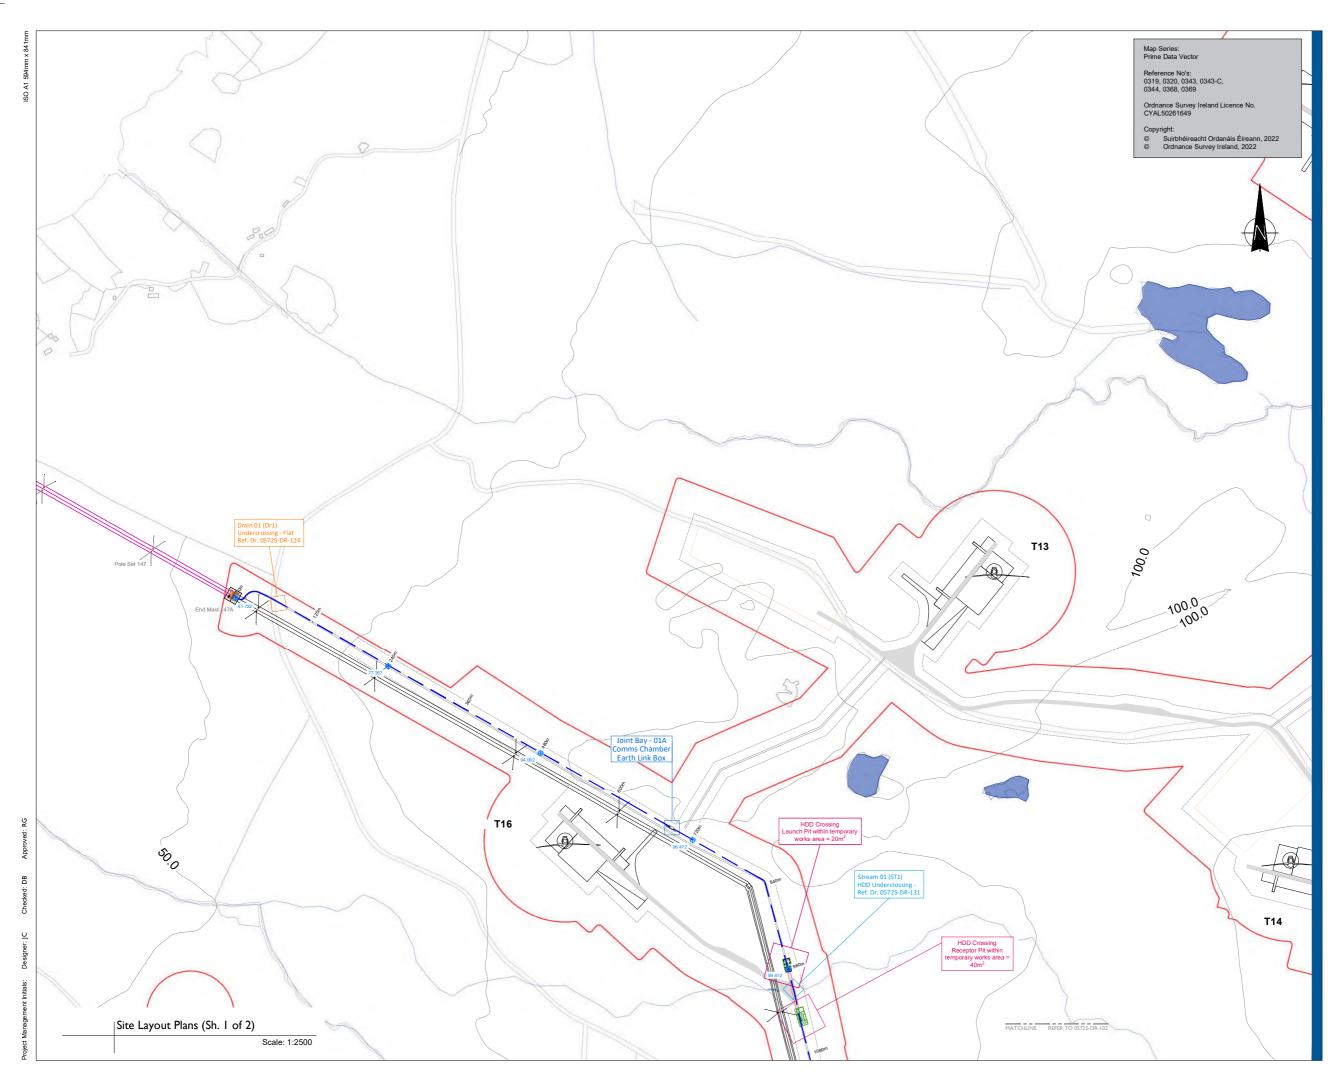



 Head Office
 Regional Office

 Beenreigh,
 Basepoint Business Centre

 Abbeydomey,
 Stoudley Road, Basingstoke

 Tralee, Co. Kerry
 Hampshire.


 Ireland
 RG24 8UP, UK

 Tel: 00353 66 7135710
 Tel: 00 44 1256406664

PROJECT

Clogherchor Wind Farm 110kV Grid Connection

CLIENT

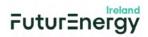



CONSULTANTS



Path of cable route and location of associated Joint Bays Link Boxes and Comms Chambers may vary depending site conditions.

Other services may be encountered along the route

This drawing is to be used only for the purpose of the planning application and is subject to detailed design.

LEGEND:

Development Boundary Existing 110kV OHL Network shown thus Retired OHL Infrastructure \equiv Existing Lake, River / Stream Network shown thus Existing ESB MV/LV OHL Network shown thus Transposed Ardnaga shown thus ry to Tievebrack LIGC _____ Access Track A T1 Turbine Location:

Turbine Hardstand

ISSUE/REVISION

P03	02.03.23	Issued for Information
P02	17.02.23	Issued for Information
P01	11.01.23	Issued for Information
P00	03.10.22	Issued for Information
F01	23.02.21	Issued for Information
F00	20.07.20	Issued for Information
I/R	DATE	DESCRIPTION


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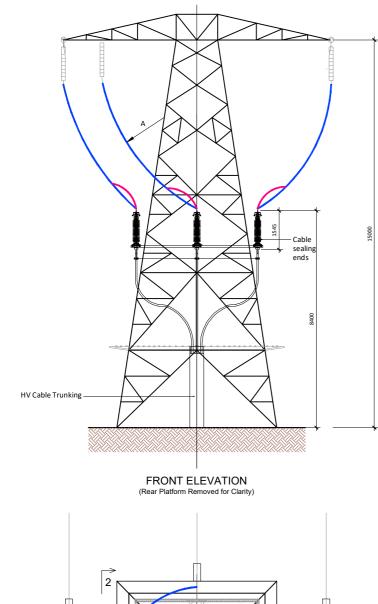
05-725


SHEET TITLE

Site Layout Plans (Sh.1 of 2)


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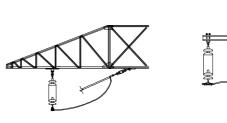





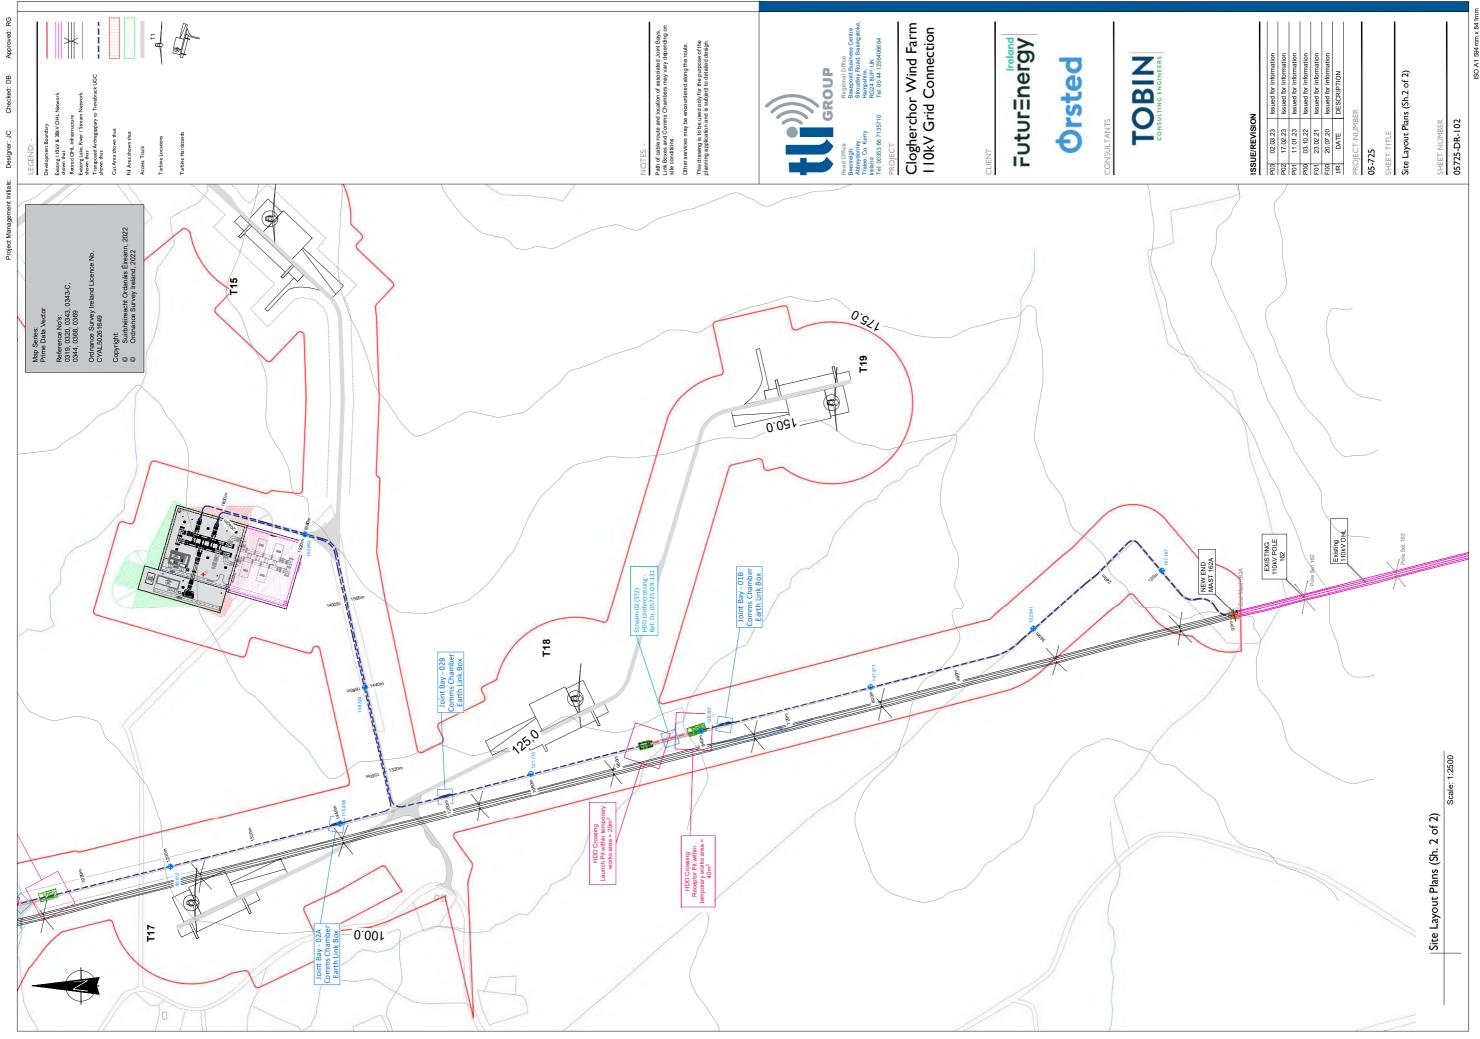

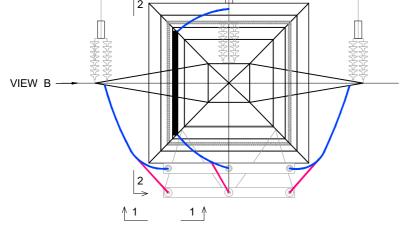PLAN VIEW



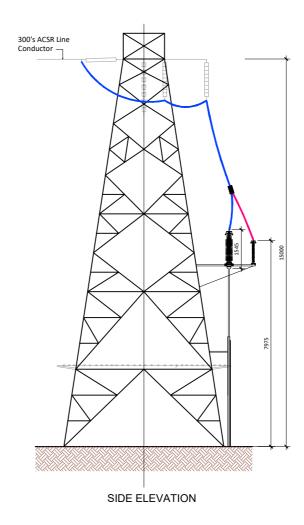

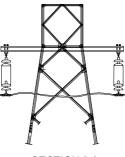

SECTION 1-1

SECTION 2-2



Beenreigh, Abbeydorney, Tralee, Co. Kerry, Ireland Tel: 00353 66 7135710

PROJECT

Clogherchor Wind Farm 110kV Grid Connection

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NOTES: -

LEGEND: -

ISSUE/REVISION


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P00 30.09.22 Issued for Information I/R DATE DESCRIPTION	_		
I/R DATE DESCRIPTION	P01	11.01.23	Issued for Information
	P00	30.09.22	Issued for Information
PROJECT NUMBER	I/R	DATE	DESCRIPTION
	PR		

05-725

SHEET TITLE

1493ET/LC excl. SW End Mast Details

SHEET NUMBER

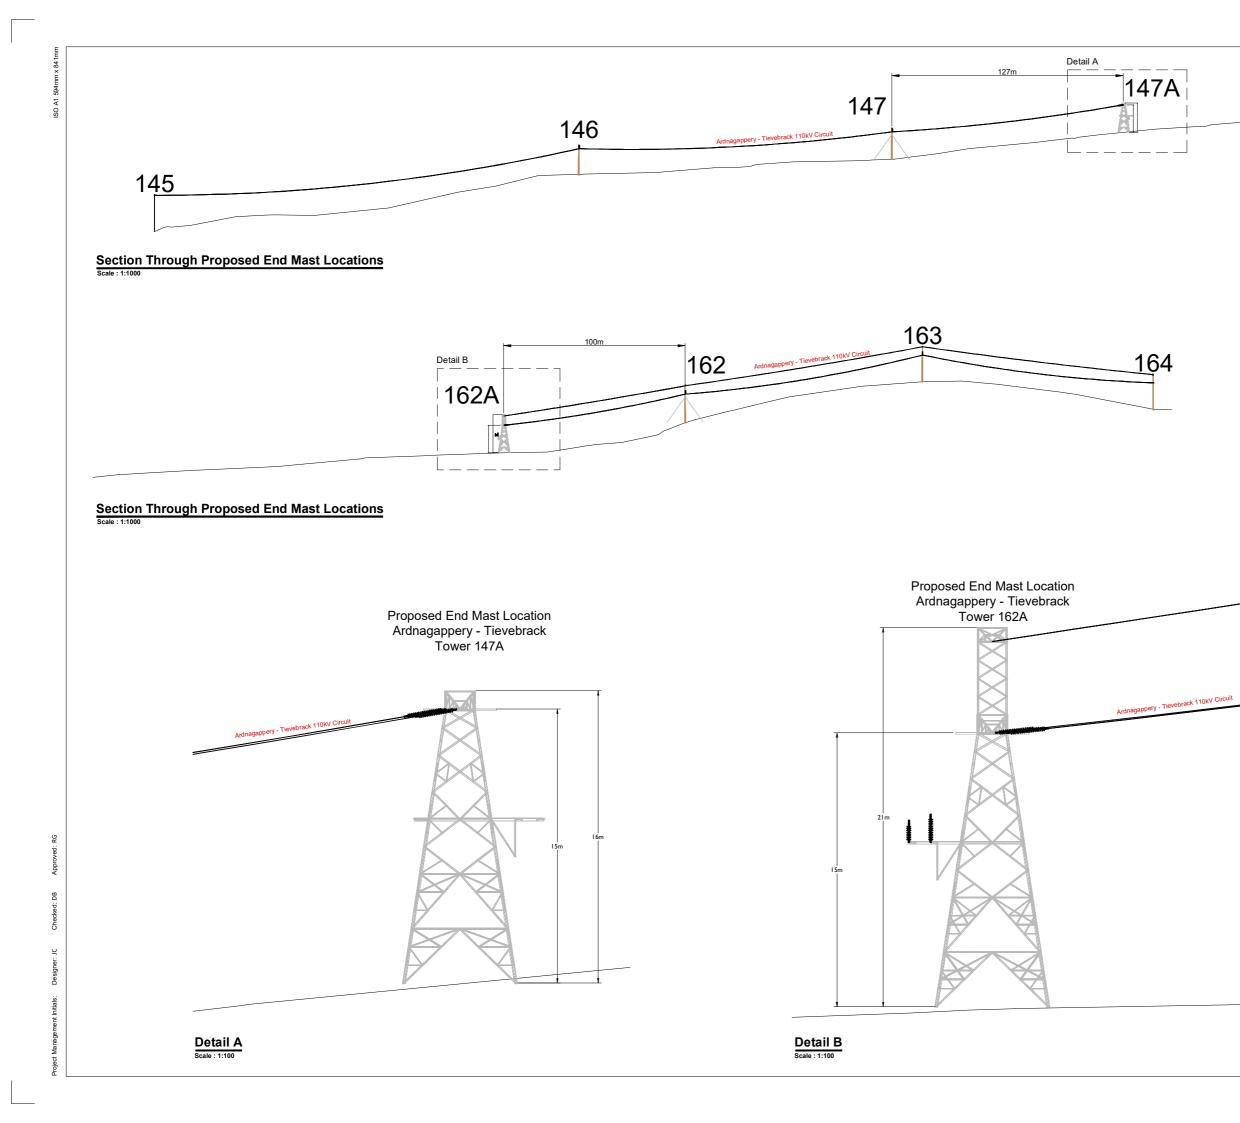



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PROJECT

Clogherchor Wind Farm 110kV Grid Connection

CLIENT





CONSULTANTS



NOTES:

- This drawing is to be read in conjuction with relevant drawings, specifications and
- with relevant drawings, specifications and reports
 Dimensions are in metres, unless noted otherwise
 Drawings are not to scale, use figured diverging and to scale.
- dimensions only. Drawing to be read in conjunction with Construction Methodology. •

LEGEND: -

Infrastructure to be re

ISSUE/REVISION


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PRO	PROJECT NUMBER			

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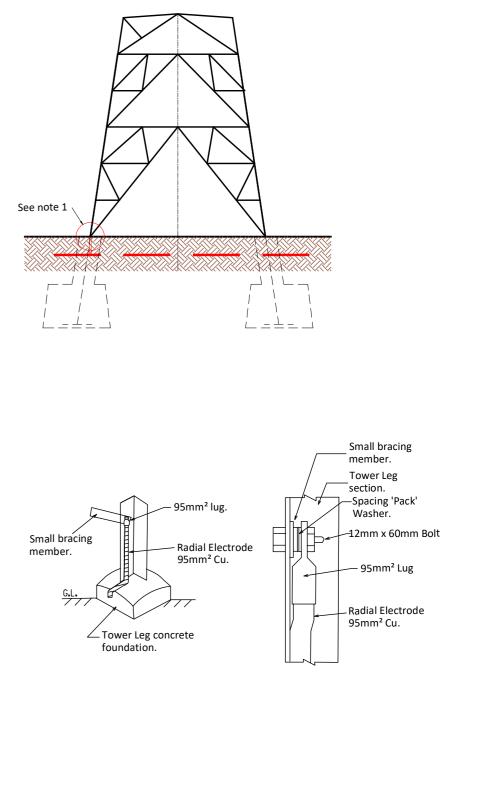
SHEET TITLE

Sections View Final Configuration


SHEET NUMBER

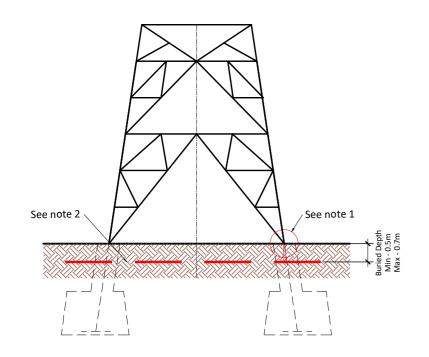

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300ACSR	1183035	





EARTH RING DETAILS - NTS

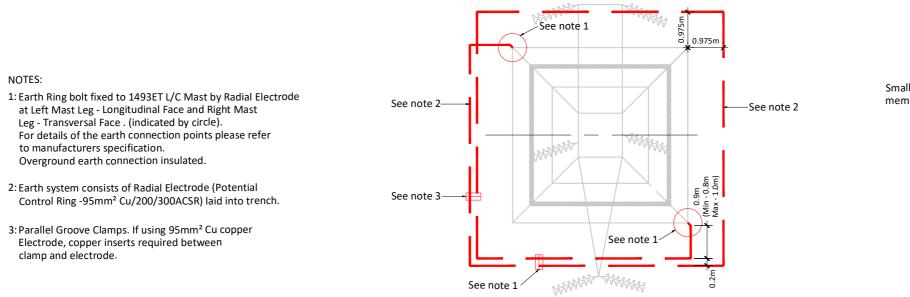

•))))	Head Office Beenreigh, Abbeydorney,		PROJECT Clogherchor Wir 110kV Grid Conr		SHEET TITLE Type 1493ET L/C Tower Earth Ring Details	
GROUP	Tralee, Co. Kerry Ireland Tel: 00353 66 7135710	Orsted	project number 05-725	SHEET NUMBER 05725-DR-109	DRAWING STATUS For Information	

ISSUE/REVISION		
P01	11.01.23	Issued for Information
P00	30.09.22	Issued for Information
I/R	DATE	DESCRIPTION

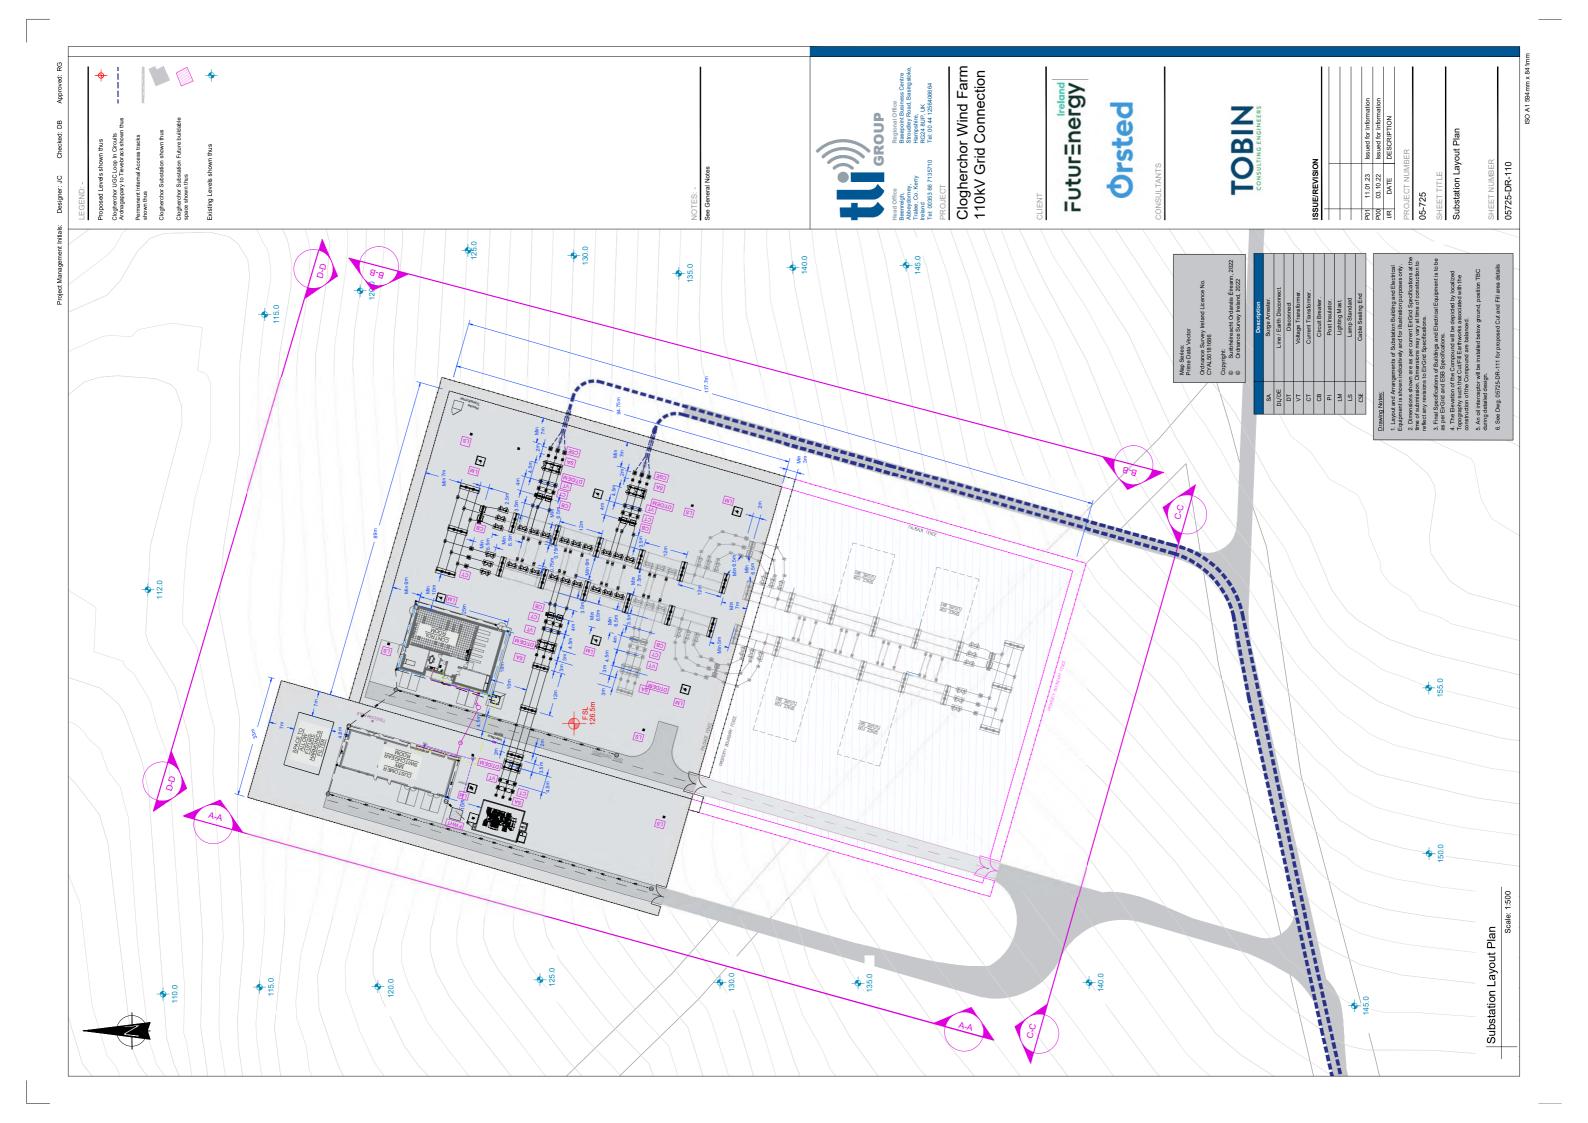

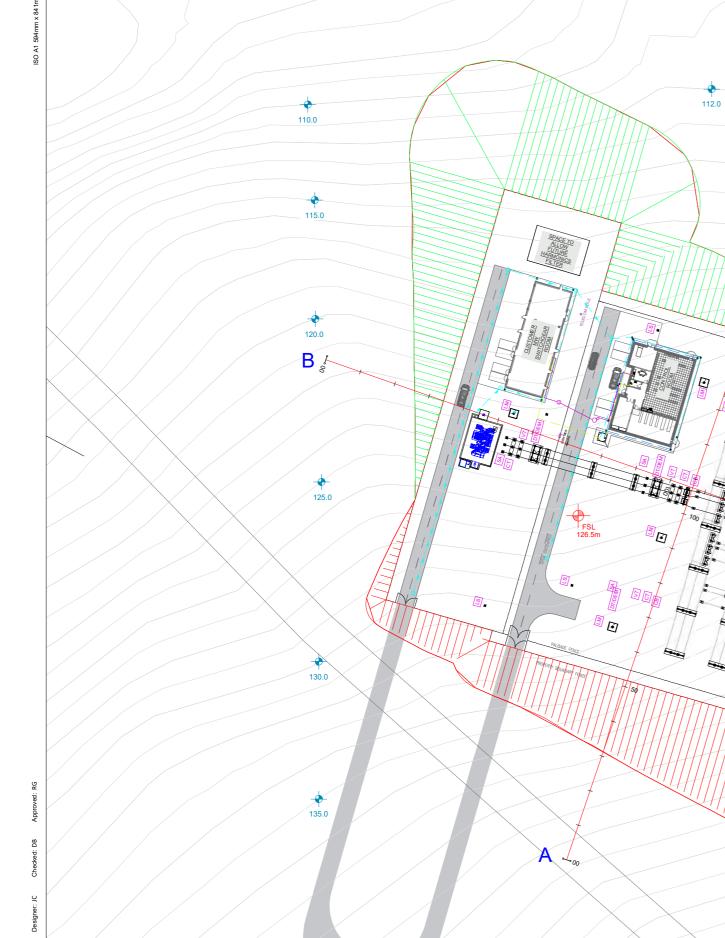



Compound Level 126.5m Cut Volume 47968m³ Fill Volume 48132m³

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115.0

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120.0

125.0

130.0

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135.0

140.0

+ 145.0

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Regional Office Basepoint Business Centre Stroudley Road, Basingstok Hampshire, RG24 8UP, UK Tel: 00 44 1256406664

PROJECT

Clogherchor Wind Farm 110kV Grid Connection

CLIENT





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1. Finished Floor Level (FFL) to local DATUM.

The Elevation of the Compound is depicted by localised Topography such that the Cut/Fill Earthworks associated with the construction of the Compound are balanced.

LEGEND:

Cut Area shown thus Fill Area shown thus

ISSUE/REVISION

P01	11.01.23	Issued for Information		
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I/R	DATE	DESCRIPTION		
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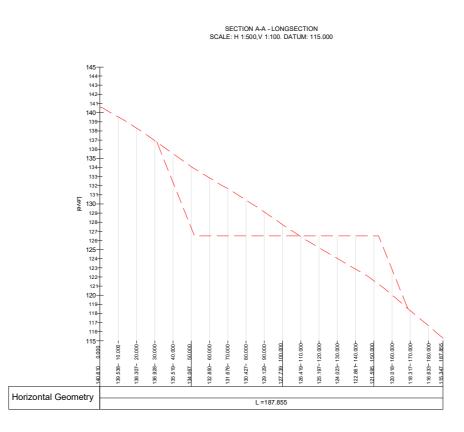
05-725


SHEET TITLE

Cut and Fill Area Layout Plan

SHEET NUMBER

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Clogherchor Wind Farm 110kV Grid Connection

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NOT

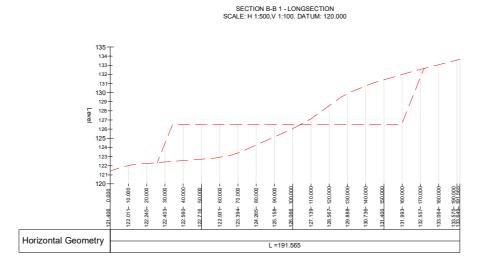- Cut & Fill gradients indicated are at a 2:1 ratio. Further slope stability works may be required to achieve this gradient on site, pending ground investigation and detailed design
 This drawings, specifications and reports
 Dimensions are in metres, unless noted otherwise
 Drawings are not to be scaled use figured dimensions only

LEGEND: -

Existing Levels shown thus

Proposed Levels shown thus

ISSUE/REVISION


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P00	10.01.2023	Issued for Information	
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PRO	PROJECT NUMBER		

05-725

SHEET TITLE Compound Sections Cut and Fill Areas

SHEET NUMBER



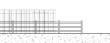



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PROJECT

Clogherchor Wind Farm 110kV Grid Connection

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NOTES

1. Layout and Arrangements of Substation Bu Electrical Equipment is shown indicatively a

- Final Specification to be as per Eirgrid
- The Elevation of the Compound will be of Topography such that Cut/Fill Earthwork the construction of the Compound are bat LEGEND: -

	Description
SA	Surge Arrester.
DL/DE	Line / Earth Disconnect.
DT	ESB Disconnect
VT	Voltage Transformer.
CT	Current Transformer.
CB	Circuit Breaker.
PI	Post Insulator.
LM	Lighting Mast.
CSE	Cable Sealing End

ISSUE/REVISION


P01	11.01.23	Issued for Information
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PRC 05-725

SHEET TITLE

Substation Compound Elevations

SHEET NUMBER

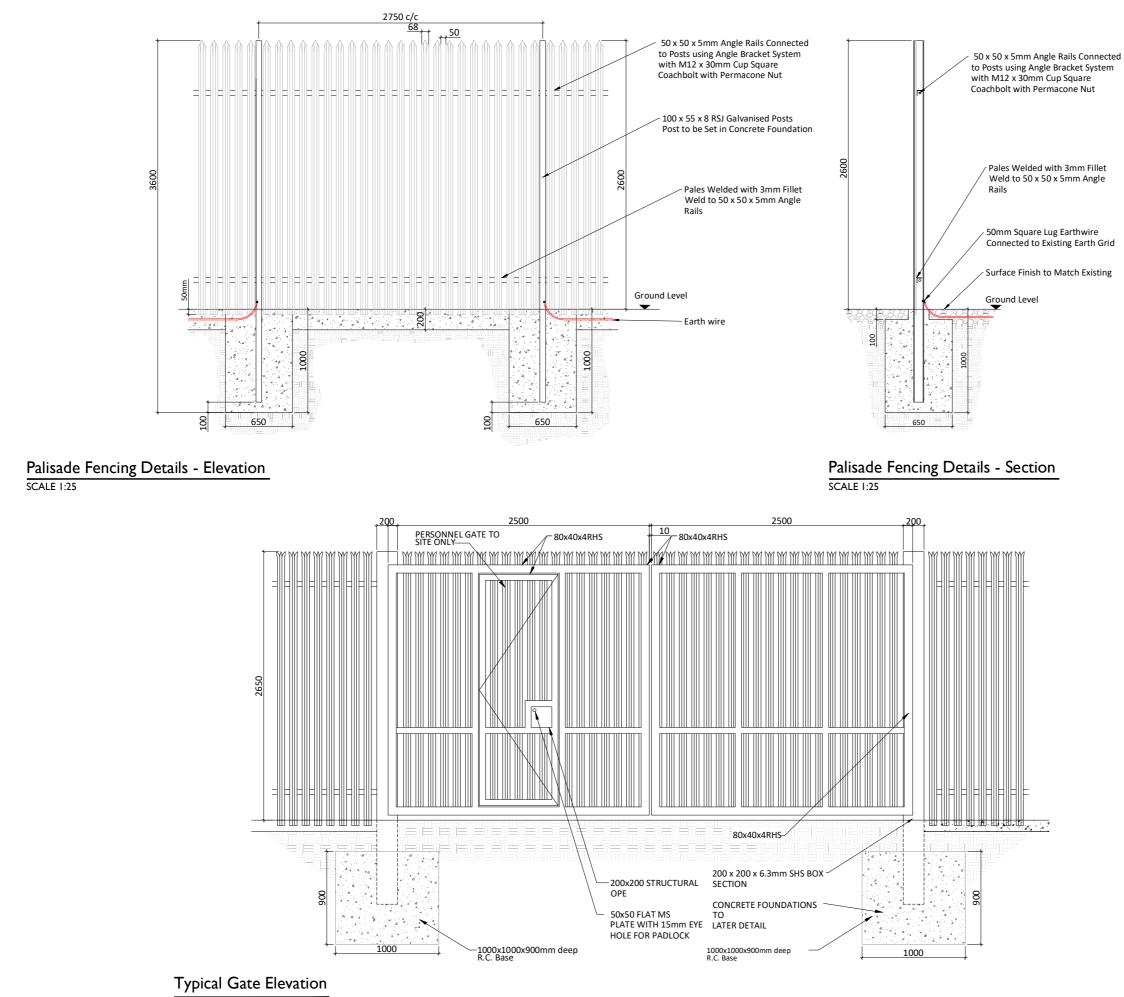

SCALE 1:25

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PROJECT

Clogherchor Wind Farm 110kV Grid Connection

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NOTES: -

LEGEND: -

- This drawing is to be read in conjuction with rele drawings, is and repo
- Dimensions are in millimetres, unless noted
- Drawings are not to be scaled use figured dimension only


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P01	11.01.23	Issued for Information	
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PROJECT NUMBER			
05-725			

SHEET TITLE

Gate & Fence Details

SHEET NUMBER



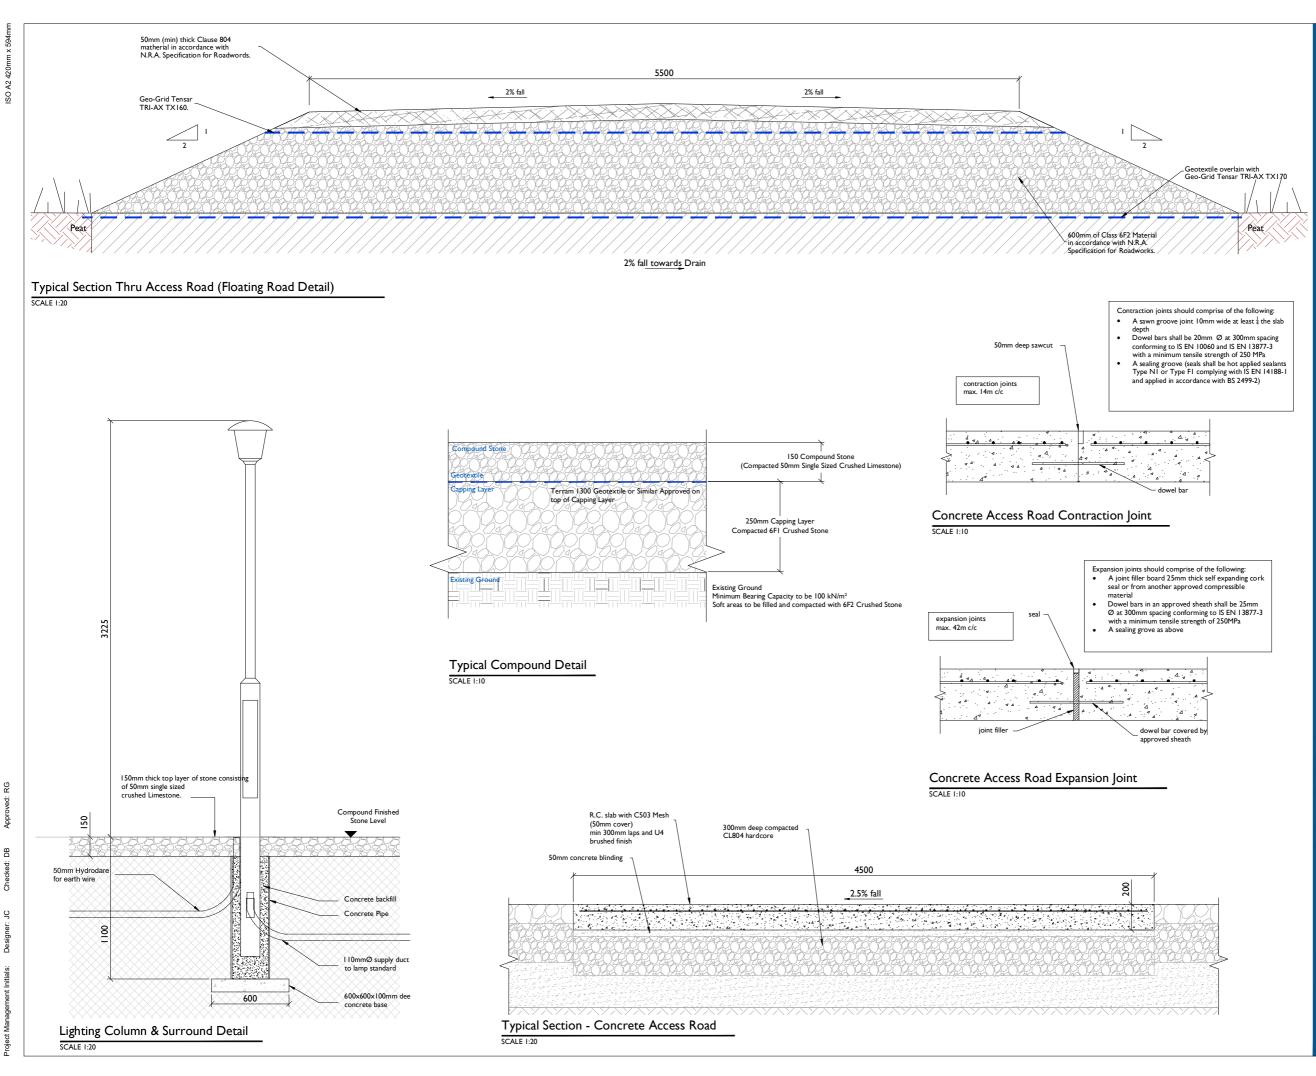

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PROJECT

Clogherchor Wind Farm 110kV Grid Connection

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NOTES: -

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- Dimensions are in millimeters, unless noted otherwis
- Drawings are not to be scaled use figured dimensions only

LEGEND: -

ISSUE/REVISION


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P01	11.01.23	Issued for Information
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05-725

SHEET TITLE

Site Compound Details & Access Road Details.

SHEET NUMBER

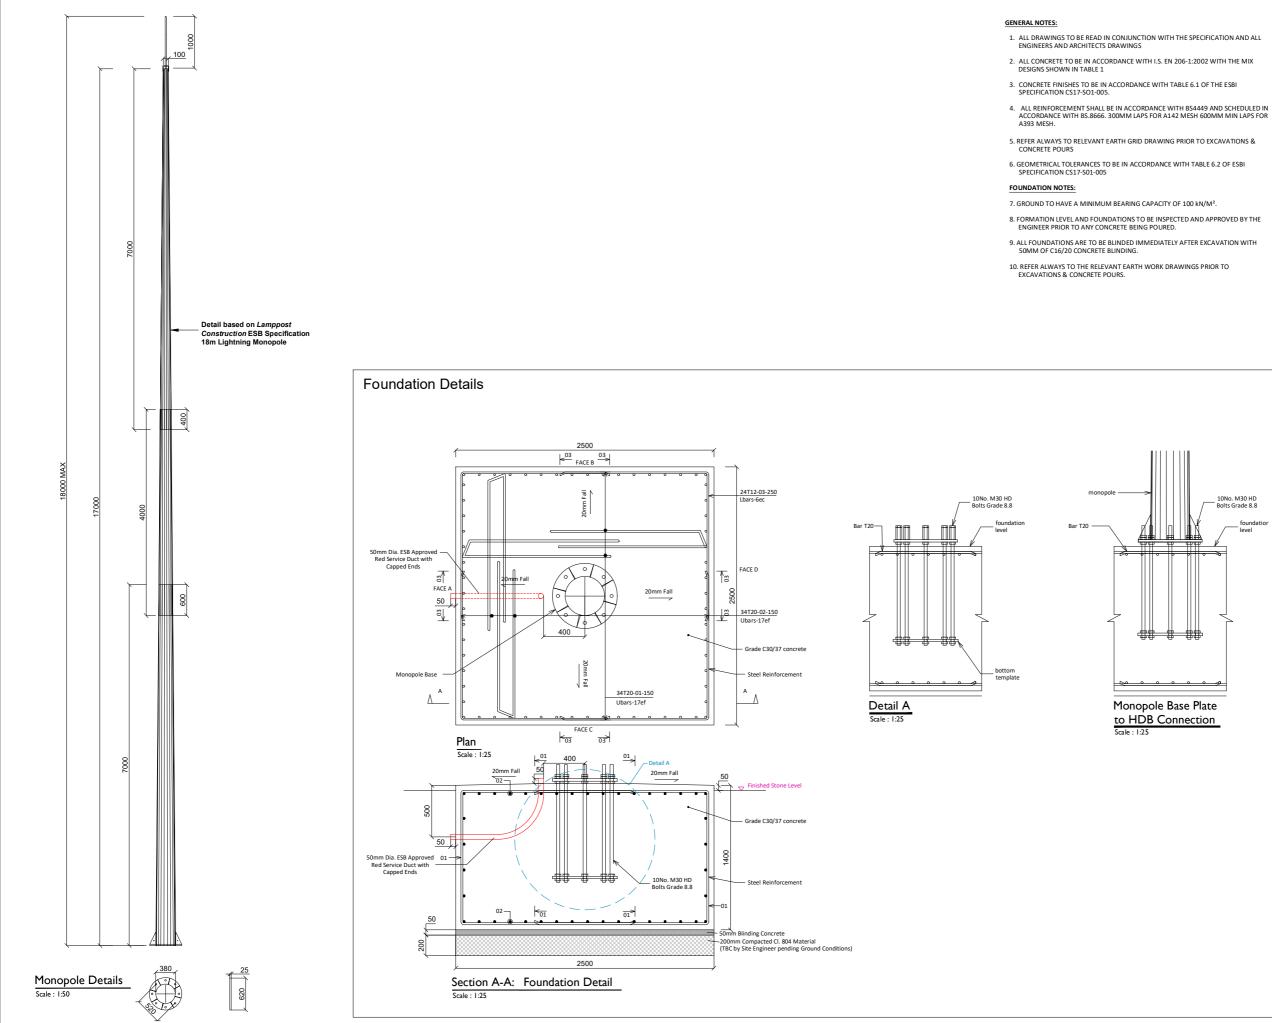

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PROJECT

Clogherchor Wind Farm 110kV Grid Connection

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NOTES: -

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- Dimensions are in millimeters, unless noted otherwise
- Drawings are not to be scaled use figured dimensions only

LEGEND: -

ISSUE/REVISION

P01 11.01.23 Issued for Information P00 03.10.22 Issued for Information I/R DATE DESCRIPTION PROJECT NUMBER PROJECT NUMBER			
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P00 03.10.22 Issued for Information I/R DATE DESCRIPTION			
P00 03.10.22 Issued for Information I/R DATE DESCRIPTION			
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	P00	03.10.22	Issued for Information
PROJECT NUMBER	I/R	DATE	DESCRIPTION
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05-725

SHEET TITLE

Lightning Monopole Foundation Details-18m Masts


SHEET NUMBER

FRONT ELEVATION Scale 1:100

006	00202		008
		Pole Lengths range up to 23m with 2.3m below Ground Level. 23m Pole Structure shown.	
		ole Lengt th 2.3m b 23m Pole	

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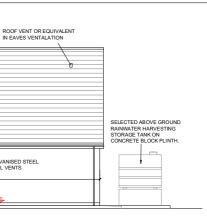
sheet title Telecoms Pole Elevation View	DRAWING STATUS LEGEND/NOTES: - Issued for Information All dimensions in mm unless noted otherwise		DS725-DR-117
CLIENT FUTURENERGY	Orsted	PROJECT Clogherchor Wind Farm	I I 0kV Grid Connection
Head Office Beenreigh, Abbeydorney, Tralee, Co. Kerry	DUP Tel: 00353 66 7135710	lected for Information	Issued for Information DESCRIPTION
		D01 23	03.10.22 DATE

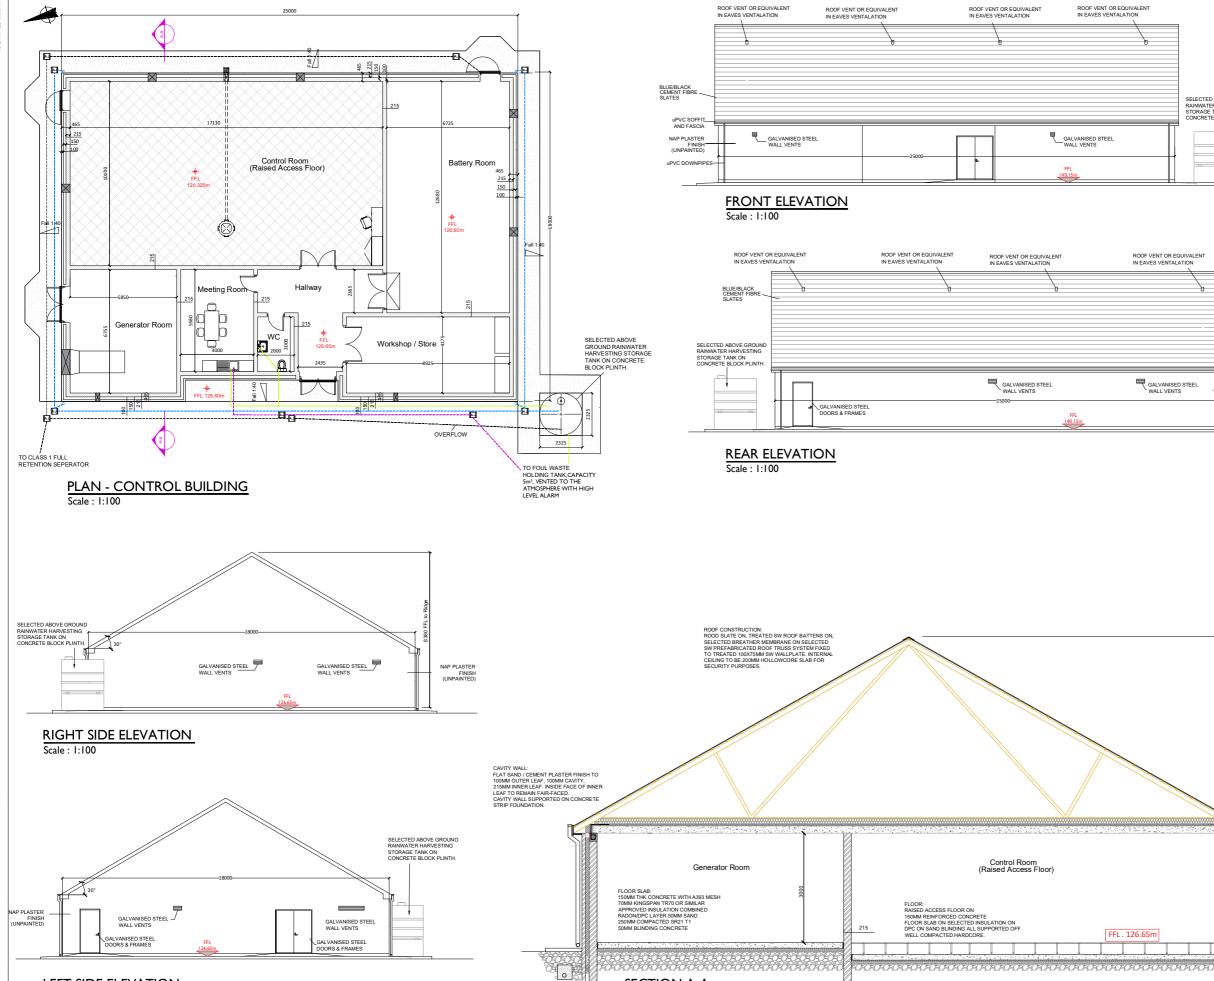



SECTION A-A

Scale : 1:50

LEFT SIDE ELEVATION Scale : 1:100



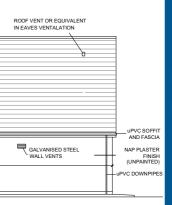

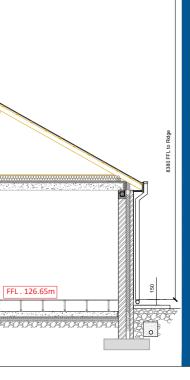



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PROJECT

Clogherchor Wind Farm 110kV Grid Connection

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NOTES:

- Layout and Arrangements of Substation Building and Electrical Equipment is shown indicatively and for illustration purposes only.
- Dimensions shown are as per current EirGrid Specification at the time of submission. Dimensions may vary at time of construction to reflect any revisions to EirGrid Specifications.
- Final Specifications of Buildings and Electrical Equipment is to be as per Eirgrid and ESB Specifications.
- The Elevation of the Compound will be depicted by Topography such that Cut/Fill Earthworks associate the construction of the Compound are balanced.

279.10m

LEGEND: -

Proposed Levels shown thus Concrete Footpath shown thus Proposed Foul Sewer shown thus Proposed Clean Storm Water shown thus

Proposed Dirty Storm Water shown thus


Vater supply from Harvesting Tank shown thus

ISSUE/REVISION

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SHE	ET TITLE	

Control Building - Plan & Elevations & Section

SHEET NUMBER

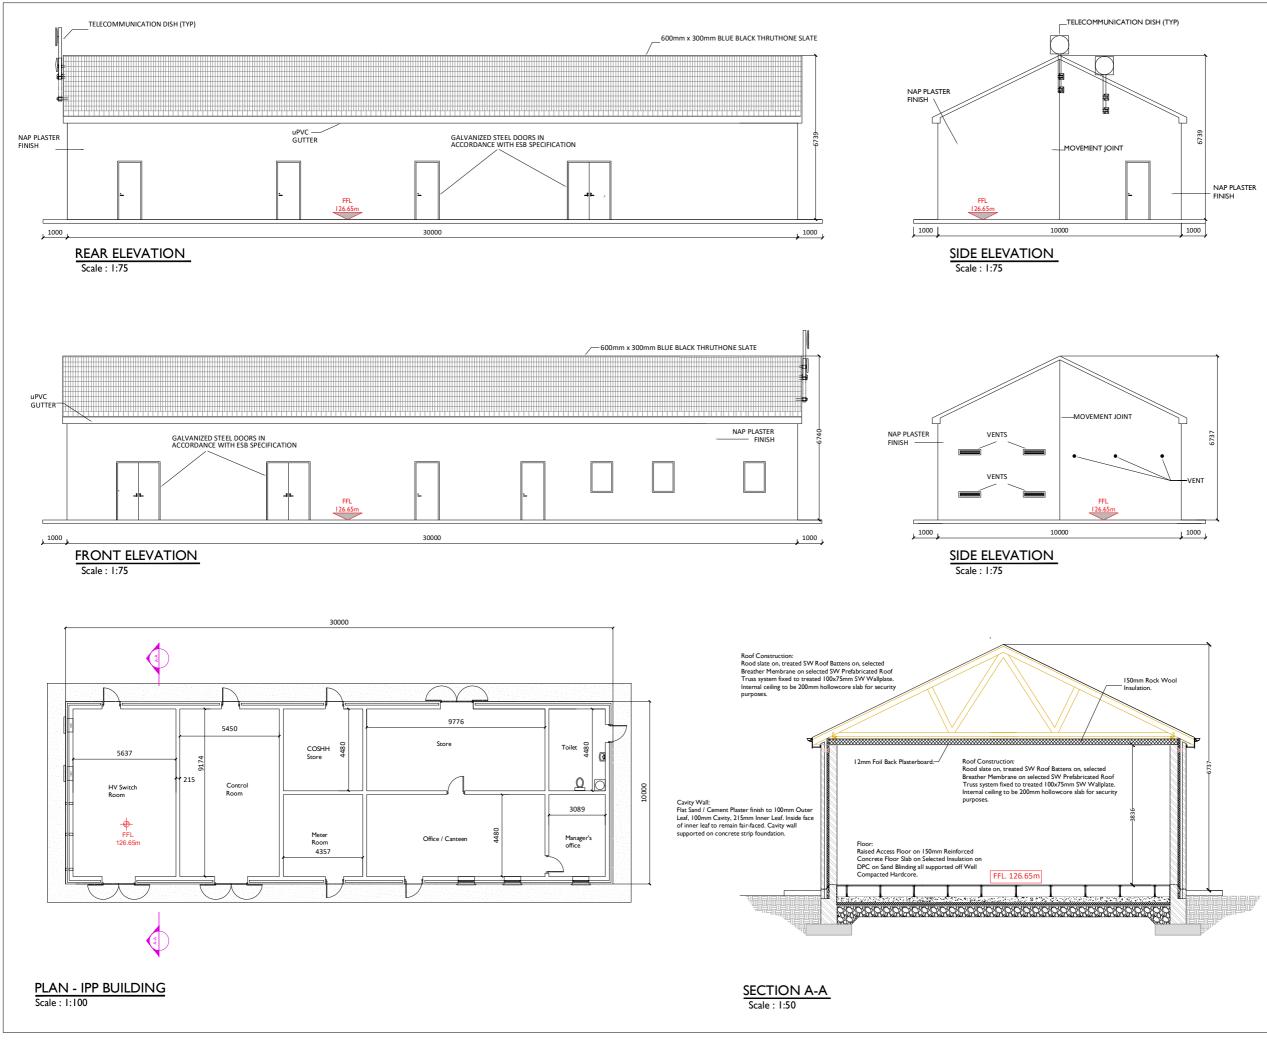



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PROJECT

Clogherchor Wind Farm 110kV Grid Connection

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NOTES:

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- Final Specifications of Buildings and Electrical Equipment is to be as per Eirgrid and ESB Specifications.
- The Elevation of the Compound will be depicted by localized Topography such that Cut/Fill Earthworks associated with the construction of the Compound are balanced.
- LEGEND: -

Proposed Levels shown thus

Concrete Footpath shown thus

279.10m

ISSUE/REVISION

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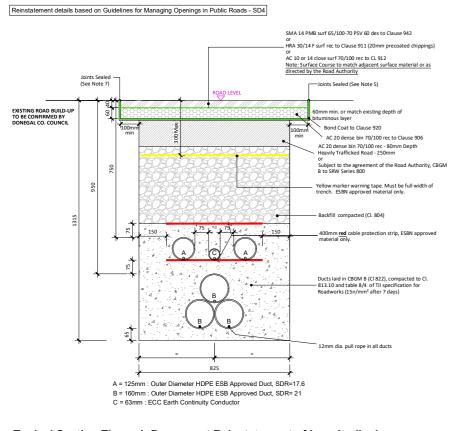
05-725

SHEET TITLE

IPP Building - Plan & Elevations & Section

SHEET NUMBER


Permanent Reinstatement




Typical Section Through Permanent Reinstatement of Longitudinal **Opening in Roadway** SCALE 1:10

SCALE 1:10



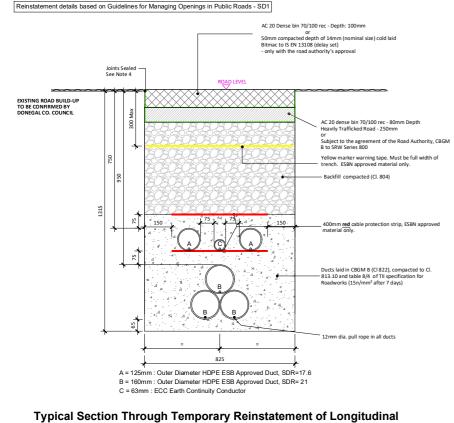


Opening in Roadway

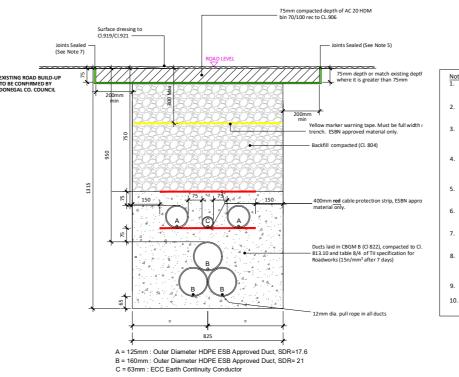


Typical Section Through Permanent Reinstatement of Longitudinal Opening in Dressed Rural Unbound Roadway

SCALE 1:10

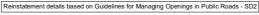

Reinstatement details based on Guidelines for Managing Openings in Public Roads - SD5

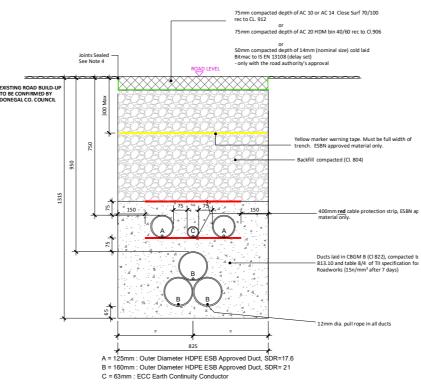

Typical Section Through Temporary Reinstatement of Longitudinal **Opening in Dressed Rural Unbound Roadway**

SCALE 1:10

OPENINGS IN PUBLIC ROADS

- Refer to Guidelines for managing Openings in Public Roads (Purple Book April 2017), Chapter 6
- THESE a COMPUTARY SURface has been used, material shall be planed out to the depth this drawing. The new permanent surface shall be machined laid and mechanically compa vibrating roller. Where a temporary surface has been used, material shall be planed out to the depth specified in
- Where the trimmed edge of excavation is within 400mm* of a joint / edge, ironwork or other reinstatement, this trimmed edge shall be extended to include same and the area of reinstatement shall be extended accordingly (* increase to 800mm where this is pre-existing practice).
- Any damaged area adjacent to the opening and resulting from the excavation operation shall be included within the area to be reinstated.
- application of Asphalt Concrete Laver

Materia

- ALL REINSTATEMENT WORKS ARE TO BE IN ACCORDANCE WITH LOCAL AREA ENGINEERS REQUIREMENTS AND GUIDELINES FOR MANAGING

- excavation. All edges shall be essentially straight, smooth and vertical.
- Clause 808 surface to be sprayed per clause 920 prior to application of Asphalt Concrete Layer
- Joint sealer shall be a hot 50 pen bitumen binder or cold thixotropic bitumen 50-70 pen to be applied to all vertical cuts in accordance with B.S. 594987 prior to application of bituminous materials.
- Licence holder must maintain temporary reinstatement to a safe and acceptable standard.
- Any damaged area adjacent to the opening and resulting from the excavation operation shall be included within the area to be reinstated.
- Temporary Road Surface warning signs must be used in accordance with the Traffic Signs Manual (Chaper 8 Temporary Traffic Measures and Signs for Roadworks).
- Refer to detail Permanent Reinstatement of Road for advice on permanent reinstatement all permanent reinstatement shall be carried out when adequate settlement has occurred as determined by the Road Authority.

ALL REINSTATEMENT WORKS ARE TO BE IN ACCORDANCE WITH LOCAL AREA ENGINEERS REQUIREMENTS AND GUIDELINES FOR MANAGING

Specifications' for guidance on Duct type / colour and Marker Tape type / colo

All bound edges shall be saw cut to expose the full vertical thickness of each layer prior to excavation. All edges shall be essentially straight, smooth and vertical.

6. Clause 808 or Cement Bound Granular Material surface to be sprayed per clause 920 prior to

Joint sealer shall be a hot 50 pen bitumen binder or cold thixtropic bitumen 50 -70 pen to be applied to all vertical cuts in accordance with B.S.594987 prior to application of bituminous materials.

 For roads without asphalt concrete surface (e.g. may be CL804 with double surface dressing), the road authority may as its discretion permit the temporary reinstatement surface of asphalt concrete to be regulated in lieu of exavation and reinstatement; and subsequently surface dressed. 9. On highly trafficked roads services must have a minimum cover of 750mm

10. Where required by the Road authority the trench may be reinstated with a Cement Bound Granula

OPENINGS IN PUBLIC ROADS

Note: 1. Refer to 'Guidelines for managing Openings in Public Roads (Purple Book - April 2017)', Chapter 6 'Specifications' for guidance on Duct type / colour and Marker Tape type / colour.

2. All bound edges shall be saw cut to expose the full vertical thickness of each layer prior to



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PROJECT

Clogherchor Wind Farm 110kV Grid Connection

CLIENT





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NOTES:

- This drawing is to be read in conjunction with relevant drawings, specifications and reports Dimensions are in millimeters, unless noted otherwise Drawings are not to be scaled use figured dimensions only Geogrid may be implemented along the cable trench route where deemed necessary by the contractor or as required by Donegal County Council

LEGEND: -

ISSUE/REVISION

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P01	11.01.23	Issued for Information
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I/R	DATE	DESCRIPTION

PROJECT NUMBER

05-725


SHEET TITLE

Typical Ducting Through Regional / Local Roadways

SHEET NUMBER

NOTES: I. This drawing is to be used for EirGrid design approval only and is not to be used for construction. 2. For further information reference the latest versions of EirGrid Dr. No. XDC-CBL-STND-H-007 & Functional Specifications in addition to all other relevant

- 3.
- - LEGEND: SECUGRID 40/40 TENSAR Tx160 (GEOTEXTILE BASE WEARING
 - PEAT COMPOSIT
 - EXISTING MATER
 - NEW ROAD BUIL

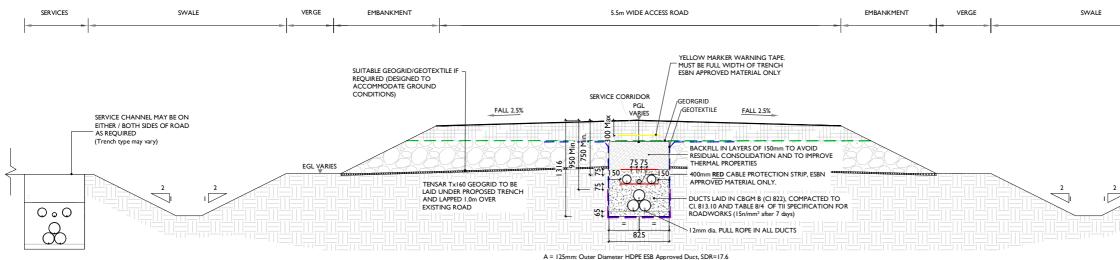


B = 160mm: Outer Diameter HDPE ESB Approved Duct, SDR=21.0

CABLE TRENCH SECTION

Scale: 1:25

ADC-LELS INUC-H-W/ & Functional Specifications in addition to all other relevant documentation. Drawings are in millimeters, unless noted otherwise. Drawings are not to be scaled, use figured dimensions only. Road-markings to be agreed with the county council and reinstated. Road surfacing build-up and tie in with non floating road sections to be agreed with the county council.

GEOGRID	
GEOGRID	
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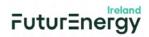
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PROJECT

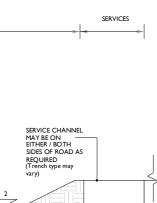Clogherchor Wind Farm 110kV Grid Connection

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NOTES:

Path of cable route and location of associated Joint Bays, Link Boxes and Comms Chambers may vary depending or site conditions.

Other services may be encountered along the route

This drawing is to be used only for the purpose of the planning application and is subject to detailed design.

LEGEND: -

ISSUE/REVISION

P02	17.02.23	Issued for Information
P01	11.01.23	Issued for Information
P00	03.10.22	Issued for Information
I/R	DATE	DESCRIPTION

PROJECT NUMBER

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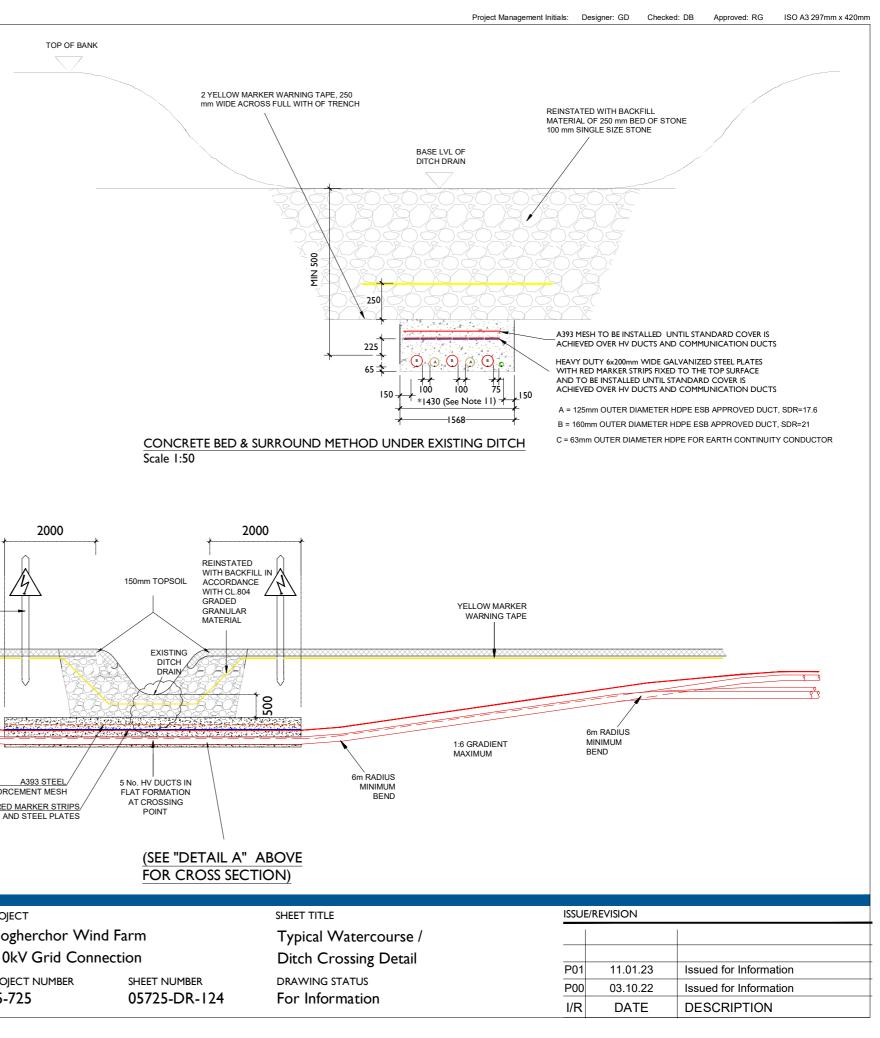
SHEET TITLE


Typical 110kV Ducting through Existing Floating Road in Peat

SHEET NUMBER

NOTES:


- I. This design is subject to EirGrid design approval.
- 2. This drawing is to be read in conjunction with all other relevant documentation.
- 3. Do not scale from this drawing, use figured dimensions only.
- 4. All dimensions are in millimeters, unless noted otherwise.
- 5. This drawing is to be read in conjunction with the Project Health and Safety File for any identified potential risks.
- 6. No excavation shall commence until the contractor has consulted up to date services drawings and carried out an electromagnetic locator (EML) scan.
- 7. Hand dig only within 500mm of existing services.
- 8. Where depths exceed 3000mm to top of duct the contractor shall consult the cable system design engineer for phase spacing requirements.
- 9. All approvals for watercourse crossing and required minimum cover to be obtained by the contractor prior to commencement of works.
- 10. ESB marker post (ESB Code: 8327355) or stub pole (2m above ground) and warning sign (ESB Code: 8238339)
- 11. Where duct for Earth Continuity Conductor (ECC) is required for single point bonded sections, attach the 63mm ECC duct to the A duct and update the trench width accordingly.




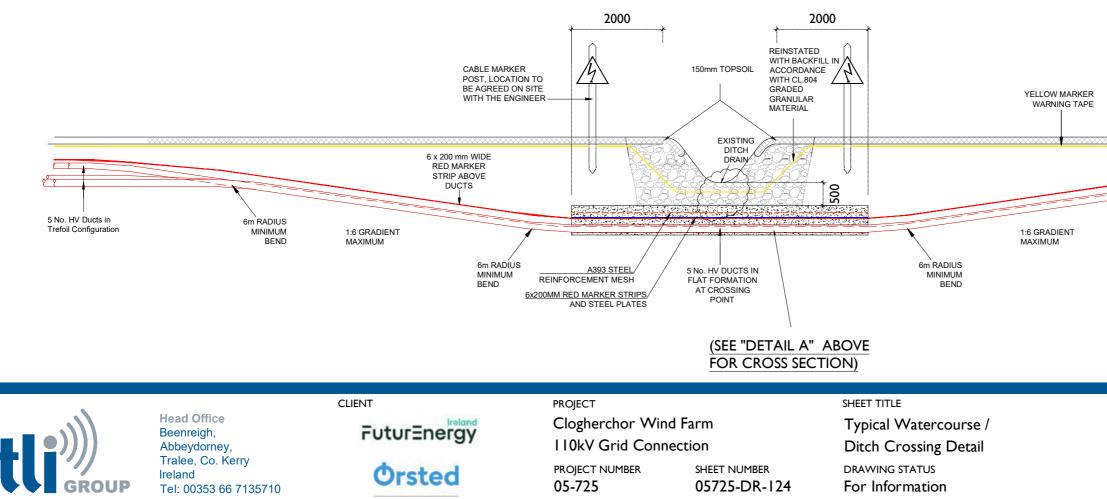




- ALL DIMENSION IN MILLISMETERS UNLESS OTHERWISE STATED
- REINSTATEMENTS TO COMPLY WITH REQUIREMENTS OF THE 2.
- RELEVANT LOCAL AUTHORITY/ASSET OWNER ENTRANCE AND EXIT DUCTS TO BE IN LINE 3.
- ALL MATERIALS AND WORKMANSHIP TO BE IN ACCORDANCE 4. WITH NRA/T.I.I. SPECIFICATION FOR ROADWORKS, MAY 2005 & SUBSEQUENT REVISIONS
- REINFORCED CONCRETE TO BE MINIMUM GRADE C32 / 40, 5. SULPHATE RESISTING CEMENT TO BE USED WHERE AGGRESSIVE SOIL CONDITIONS APPLY, REFER TO TABLE 6.1 OF THE BRITISH STANDARD 8110.
- CARRAIGEWAY COVERS AND FRAMES TO BE TO B.S EN 124. 6. ALL COVERS SHALL HAVE "ESB" LOGO INCORPORATED IN THEM 7.
- TO THE APPROVAL OF EIRGRID STEP IRONS TO BE GOT DIPPED GALVANISED TO B.S 729 AND 8.
- POSITIONED AS SHOWN ON ANY CHAMBER DEEPER THAN 700mm ON THE END REMOTE FROM ANY SIDE ENTRY DUCT.
- CONCRETE PRECAST CHAMBER AND COVER TO BE TESTED 9. THROUGH 5 POINTS, 40 TONNES VERTICAL STATIC LOADING TEST BY AN INDEPENDENT TEST COMPANY. IF REQUIRED, FURTHER DETAILS WILL BE PROVIDED BY EIRGRID.
- 10. FINAL POSITION OF C2 CHAMBERS SHALL BE AGREED WITH EIRGRID
- IN A FOREST ENVIROMENT, BACKFILL WITH LEAN MIX OUTSIDE 11. THE COVER FRAME WHERE THE ASPHALT IS SHOWN

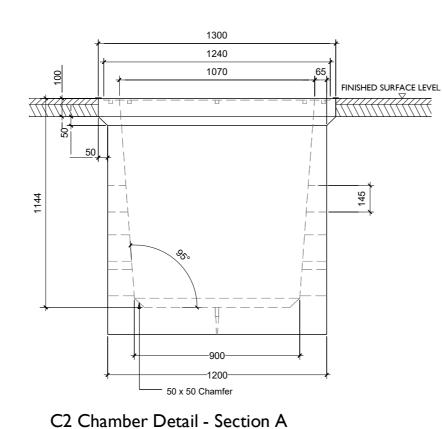


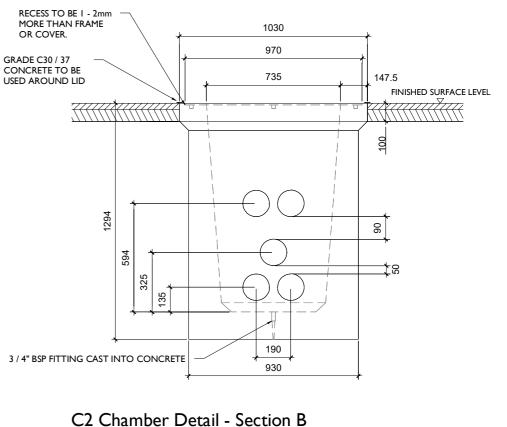

SCALE 1:20

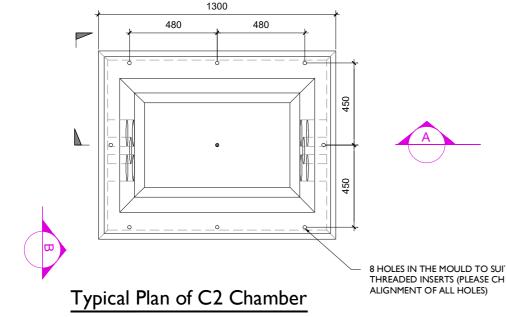

SCALE 1:20

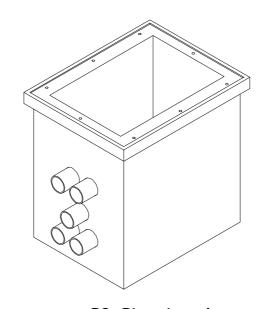



Isometric : C2 Chamber Arrangement SCALE 1:20

CLIENT PROJECT SHEET TITLE **Head Office Clogherchor Wind Farm** FuturEnergy Typical Communications Beenreigh, 110kV Grid Connection **Chamber Details** Abbeydorney, Tralee, Co. Kerry PROJECT NUMBER DRAWING STATUS SHEET NUMBER Orsted Ireland 05-725 05725-DR-125 For Information OUP Tel: 00353 66 7135710

SCALE 1:20

ISSU	e/revision	
P01	11.01.23	Issued for Information
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PROJECT

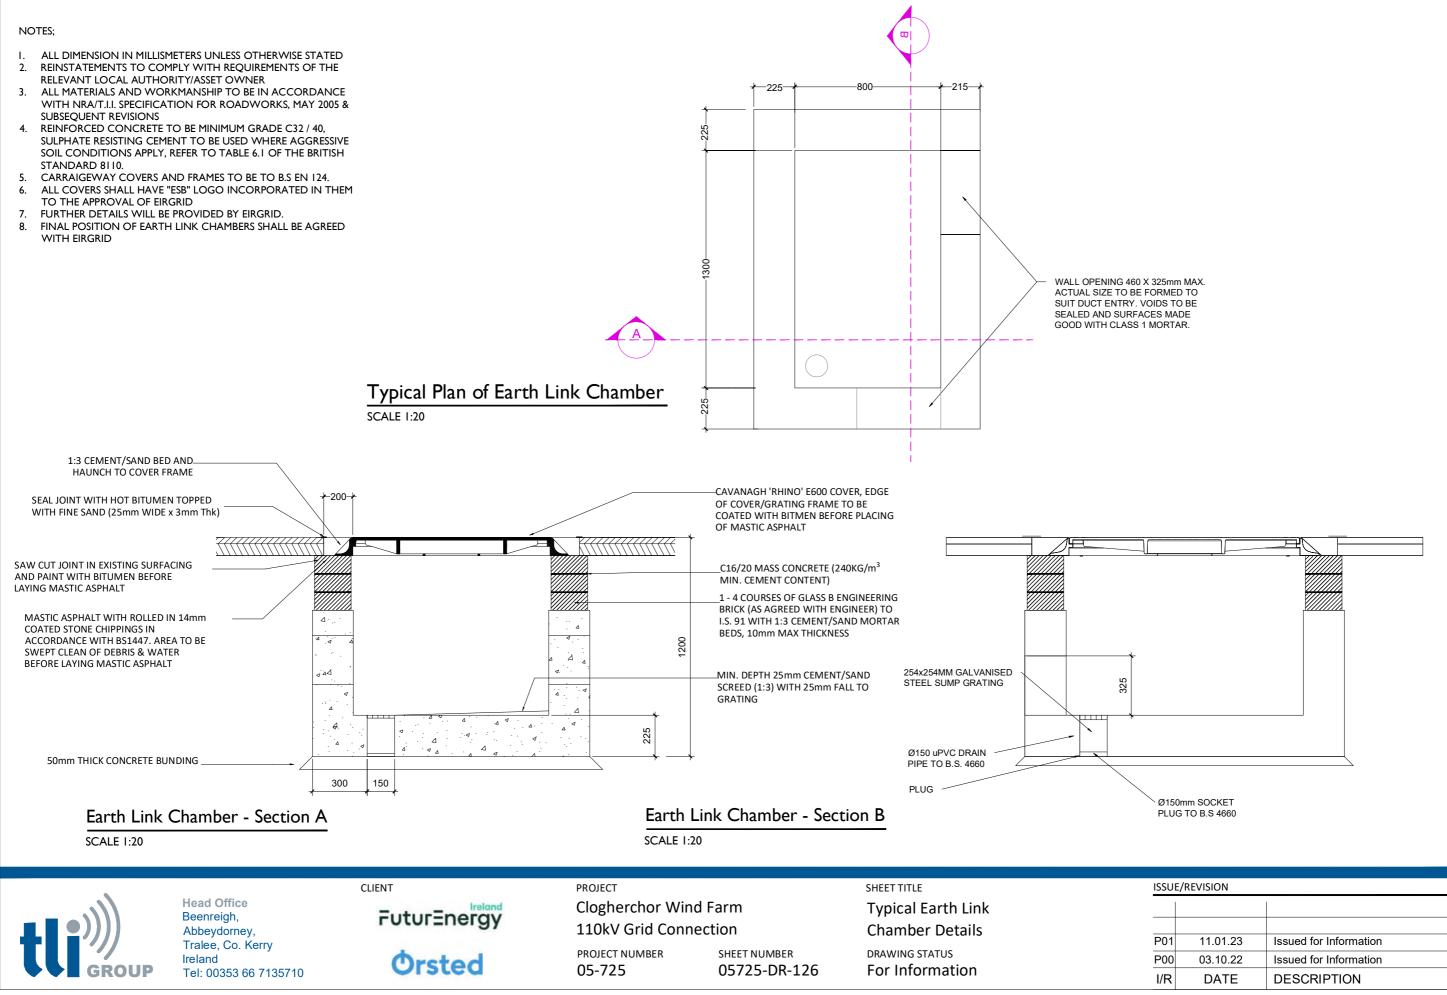Clogherchor Wind Farm 110kV Grid Connection
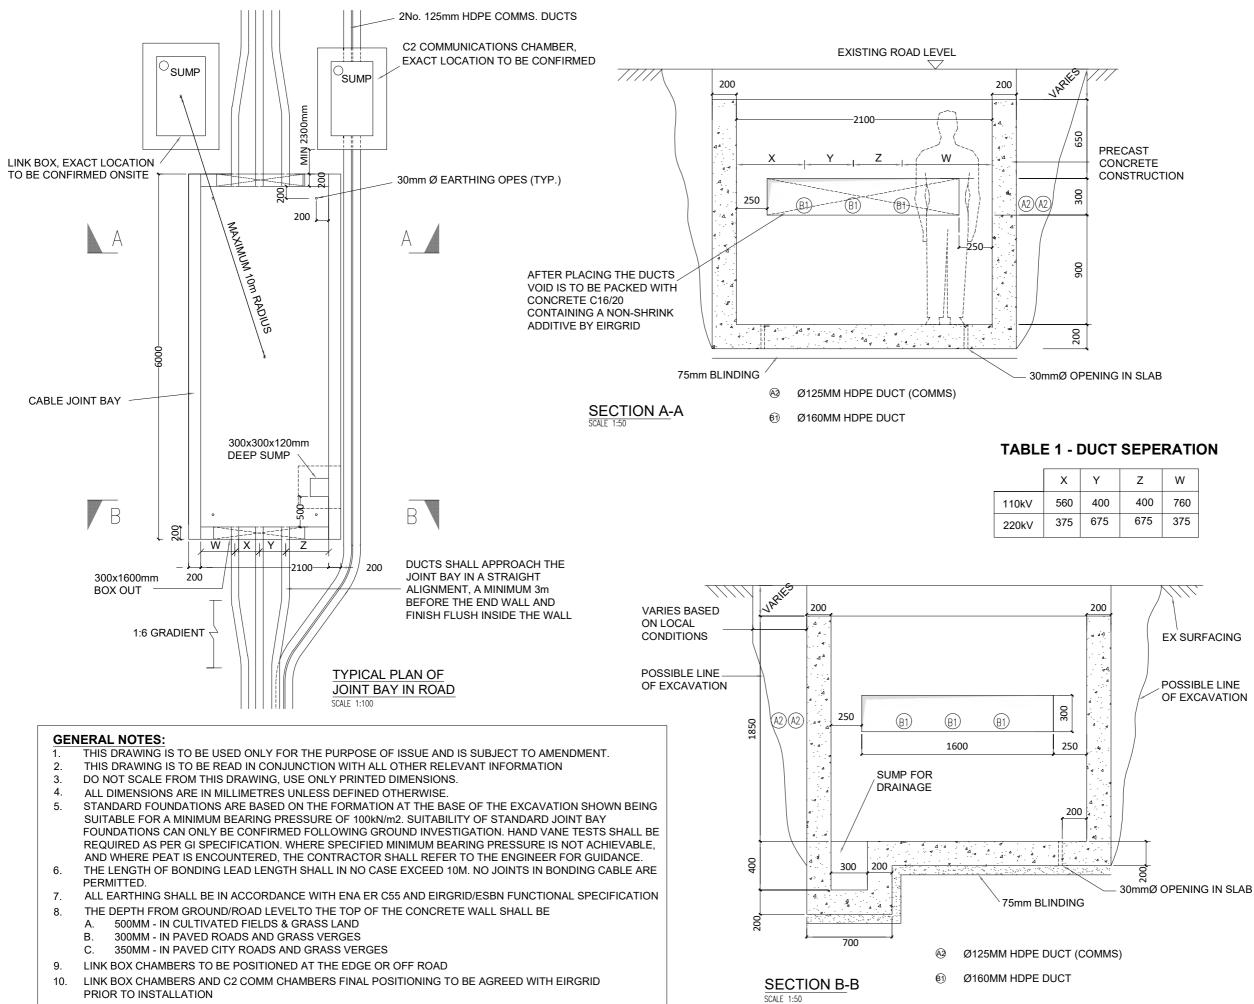
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NOTES: See General Notes

LEGEND: ·

ISSUE/REVISION


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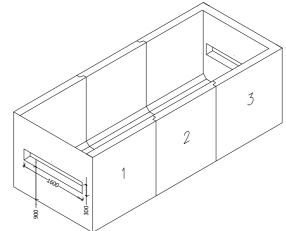
05-725

SHEET TITLE

110kV Joint Bay Section details

SHEET NUMBER 05725-DR-127



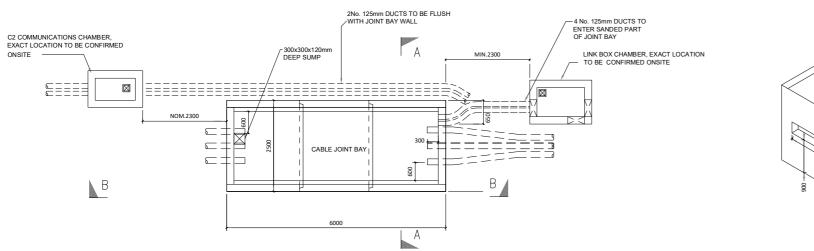


PLAN VIEW SCALE 1:50

ALL EARTHING SHALL BE IN ACCORDANCE WITH ENA ER C55 AND EIRGRID/ESBN FUNCTIONAL SPECIFICATION

ALL BARTHING SHALL BE IN ACCORDANCE WITH ENA EN C35 AND EINGRÜDESBIN FÜNCTION THE DEPTH FROM GROUDNIROAD LEVELTO THE TOP OF THE CONCRETE WALL SHALL BE A. 500MM - IN CULTIVATED FIELDS & GRASS LAND B. 300MM - IN PAVED CITY ROADS AND GRASS VERGES C. 350MM - IN PAVED CITY ROADS AND GRASS VERGES

UINK BOX CHAMBERS TO BE POSITIONED AT THE EDGE OR OFF ROAD
 LINK BOX CHAMBERS AND C2 COMM CHAMBERS FINAL POSITIONING TO BE AGREED WITH EIRGRID
 PRIOR TO INSTALLATION

ISOMETRIC VIEW PRECAST CHAMBER SCALE 1:50

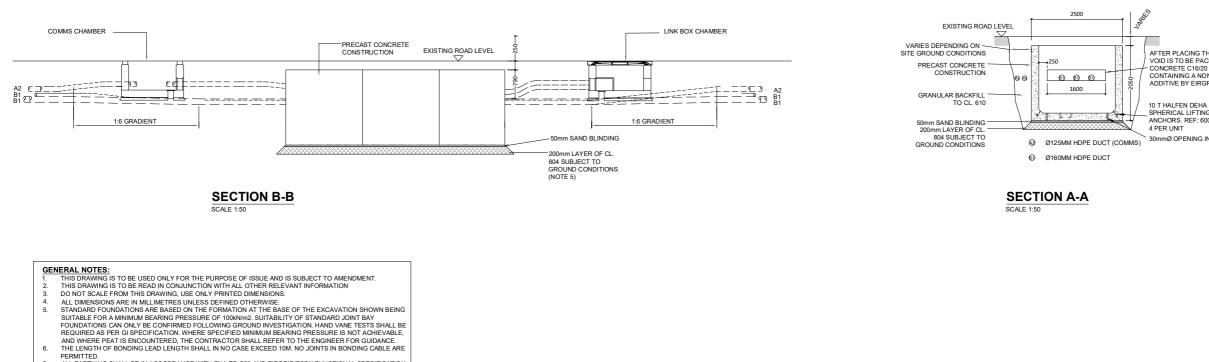

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PROJECT

Clogherchor Wind Farm 110kV Grid Connection

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NOTES:

See General Notes

LEGEND: -

ISSUE/REVISION

P01	11.01.23	Issued for Information
P00	03.10.22	Issued for Information
I/R	DATE	DESCRIPTION

PROJECT NUMBER

05-725

SHEET TITLE 110kV Joint Bay General Arrangement and Details


SHEET NUMBER

05725-DR-128

AFTER PLACING THE DUCTS VOID IS TO BE PACKED WITH - CONCRETE C16/20 CONTAINING A NON-SHRINK ADDITIVE BY EIRGRID

SPHERICAL LIFTING ANCHORS. REF: 6000-10.0-0170 4 PER UNIT

30mmØ OPENING IN SLAB

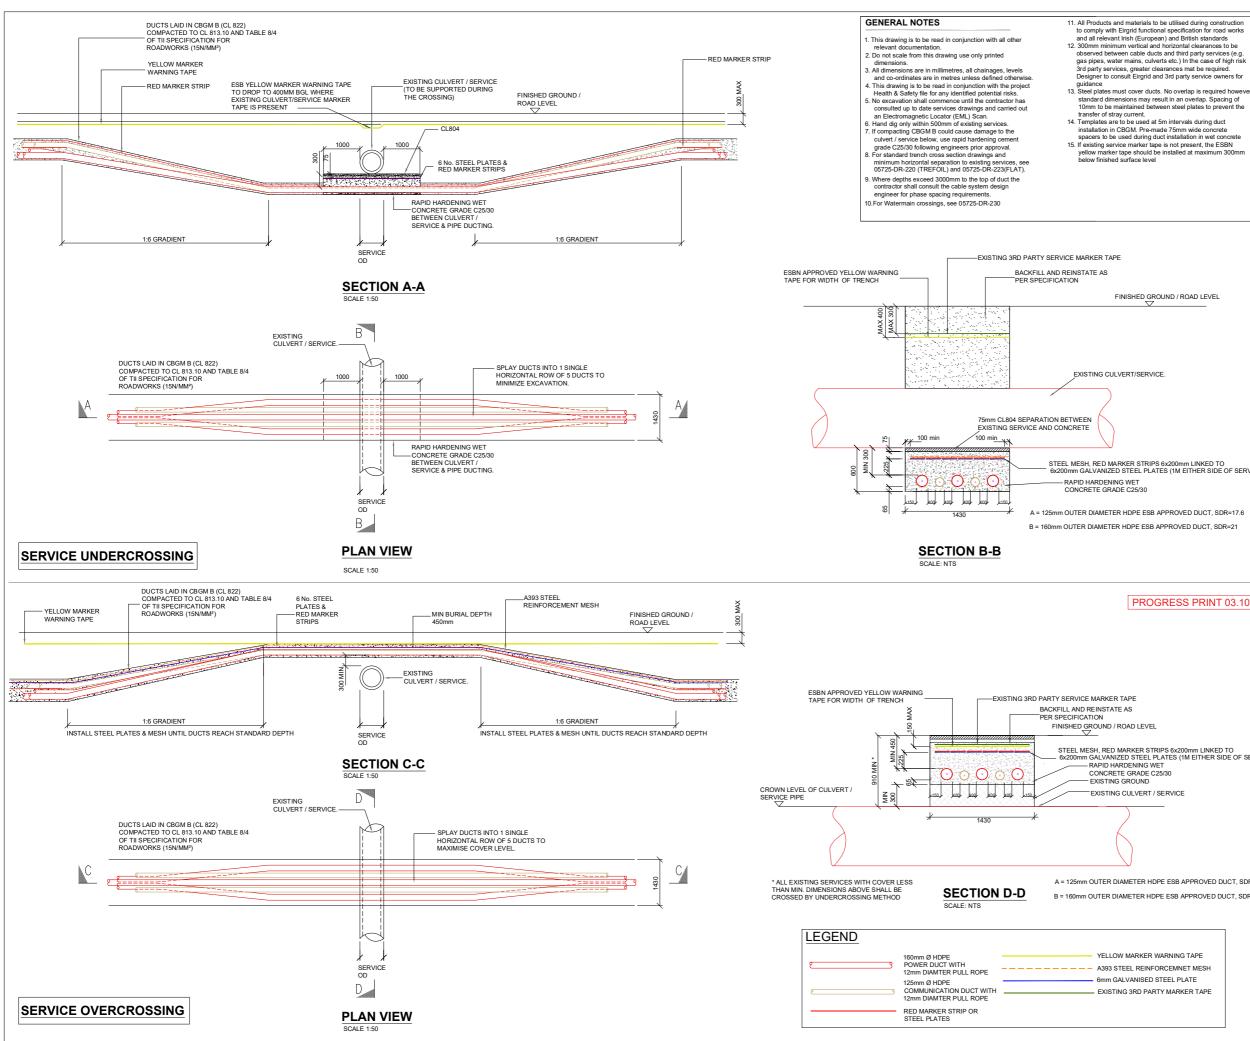

11. All Products and materials to be utilised during construction to comply with Eirgrid functional specification for road works and all relevant Irish (European) and British standards 12. 300mm minimum vertical and horizontal clearances to be observed between cable ducts and third party services (e.g. gas pipes, water mains, culverts etc.) In the case of high risk

FINISHED GROUND / ROAD LEVEL

STEEL MESH, RED MARKER STRIPS 6x200mm LINKED TO 6x200mm GALVANIZED STEEL PLATES (1M EITHER SIDE OF SERVICE)

PROGRESS PRINT 03.10.22

STEEL MESH, RED MARKER STRIPS 6x200mm LINKED TO 6x200mm GALVANIZED STEEL PLATES (1M EITHER SIDE OF SERVICE)

EXISTING CULVERT / SERVICE

A = 125mm OUTER DIAMETER HDPE ESB APPROVED DUCT, SDR=17.6 B = 160mm OUTER DIAMETER HDPE ESB APPROVED DUCT, SDR=21

> YELLOW MARKER WARNING TAPE 6mm GALVANISED STEEL PLATE - EXISTING 3RD PARTY MARKER TAPE



Beenreigh, Tralee, Co. Kerry Tel: 00353 66 7135710 Basepoint Business Centre Stroudley Road, Basingstoke, Hampshire, RG24 8UP, UK Tel: 00 44 1256406664

PROJECT

Clogherchor Wind Farm 110kV Grid Connection

CLIENT



CONSULTANTS



See General Notes

LEGEND: ·

ISSUE/REVISION

P02	11.01.23	Issued for Information
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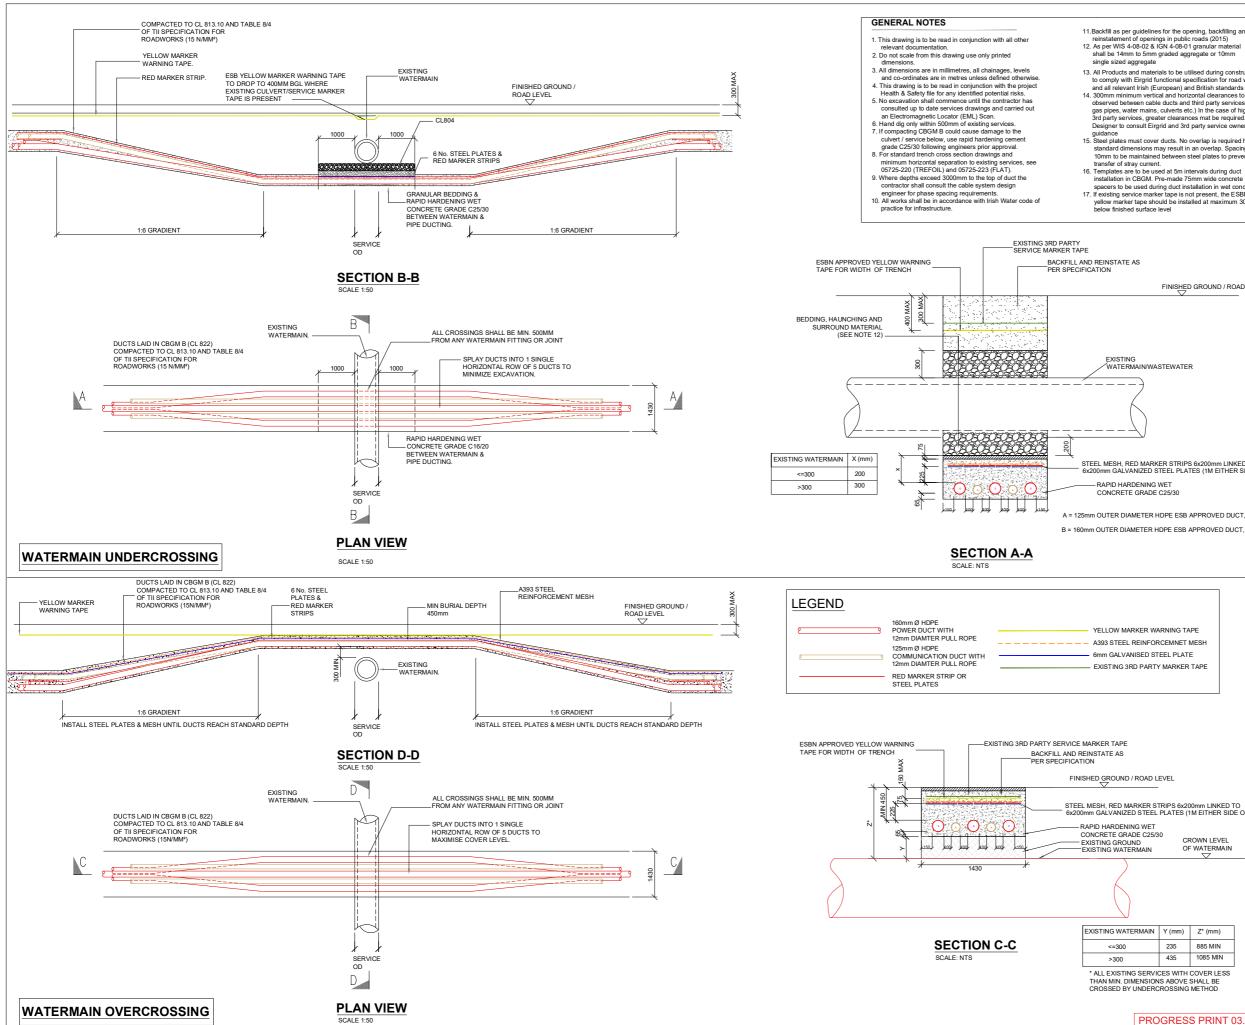
PROJECT NUMBER

05-725

SHEET TITLE

Typical Trench Sections for Crossing Existing Culverts/Services

SHEET NUMBER



Backfill as per guidelines for the opening, backfilling and reinstatement of openings in public roads (2015)
 As per WIS 4-08-02 & IGN 4-08-01 granular material shall be 14mm to 5mm graded aggregate or 10mm single sized aggregate

single sized aggregate
13. All Products and materials to be utilised during construction to comply with Eirgrid functional specification for road works and all relevant Irish (European) and British standards
14. 300mm minimum vertical and horizontal clearances to be observed between cable ducts and third party services (e.g., gas pipes, water mains, culverts etc.) In the case of high risk 3rd party services, greater clearances mat be required. Designer to consult Eirgrid and 3rd party service owners for guidance

guidance 15. Steel plates must cover ducts. No overlap is required howeve standard dimensions may result in an overlap. Spacing of 10mm to be maintained between steel plates to prevent the

- spacers to be used during duct installation in wet concrete 17. If existing service marker tape is not present, the ESBN
- yellow marker tape should be installed at maximum 300mm below finished surface level

FINISHED GROUND / ROAD LEVEL

WATERMAIN/WASTEWATER

STEEL MESH, RED MARKER STRIPS 6x200mm LINKED TO 6x200mm GALVANIZED STEEL PLATES (1M EITHER SIDE OF SER)

A = 125mm OUTER DIAMETER HDPE ESB APPROVED DUCT, SDR=17.6 B = 160mm OUTER DIAMETER HDPE ESB APPROVED DUCT, SDR=21

> YELLOW MARKER WARNING TAPE 6mm GALVANISED STEEL PLATE EXISTING 3RD PARTY MARKER TAPE

STEEL MESH RED MARKER STRIPS 6x200mm LINKED TO n GALVANIZED STEEL PLATES (1M EITHER SIDE OF SERVICE)

TERMAIN		
)		

ATERMAIN	Y (mm)	Z

0	235	885 MIN
	435	1085 MIN

* ALL EXISTING SERVICES WITH COVER LESS THAN MIN. DIMENSIONS ABOVE SHALL BE CROSSED BY UNDERCROSSING METHOD

PROGRESS PRINT 03.10.22

' (mm)



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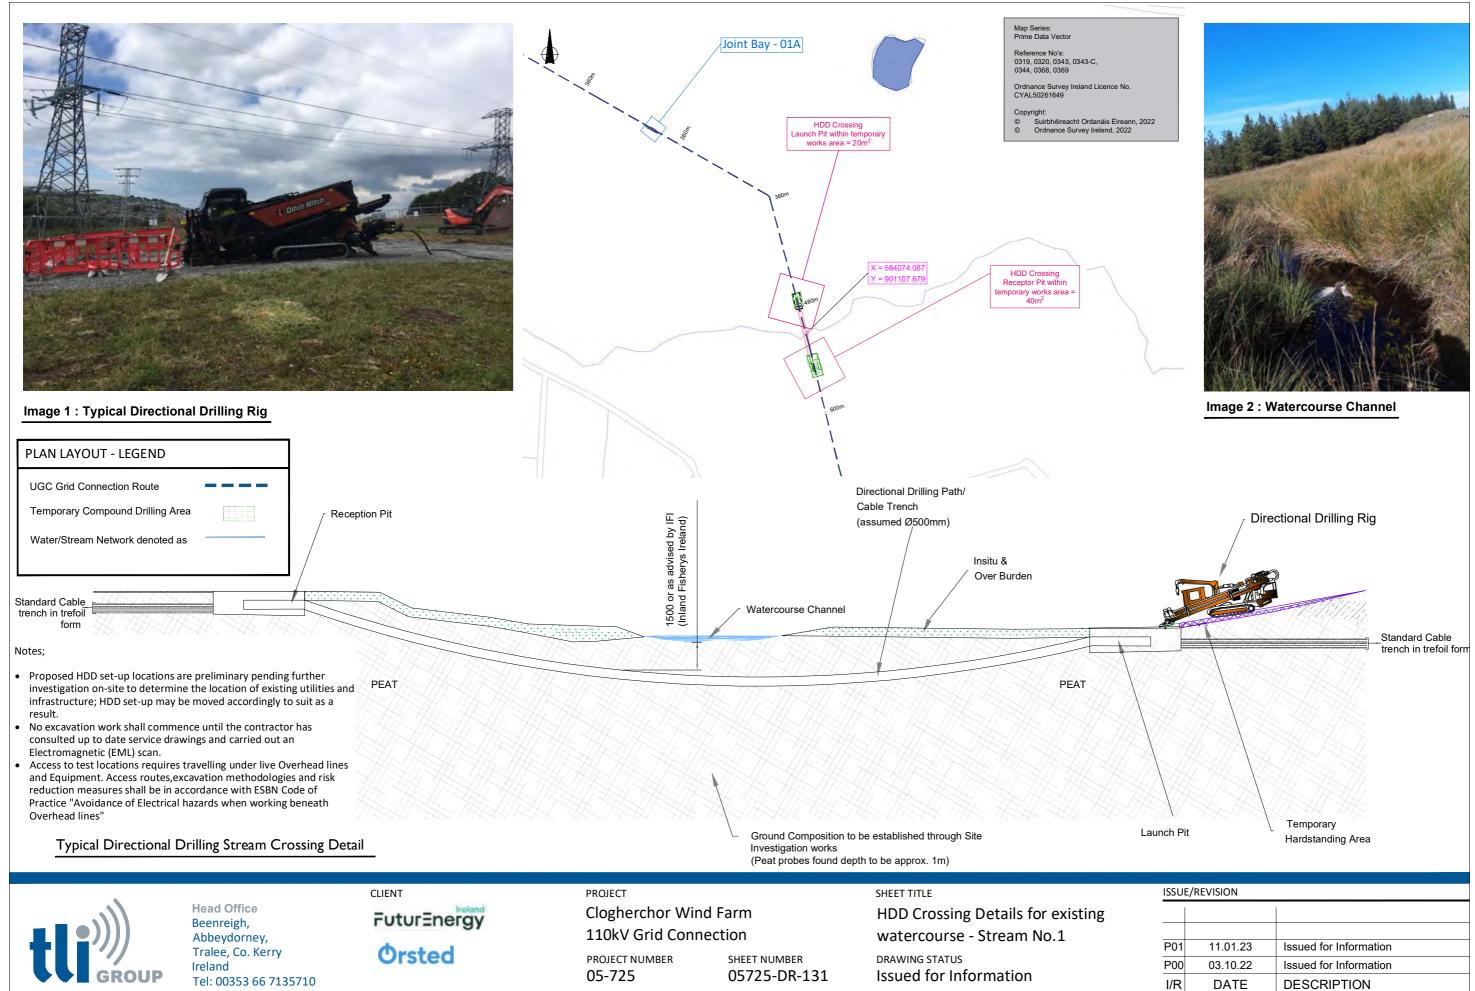
PROJECT NUMBER

05-725

SHEET TITLE


Typical Trench Sections for Crossing Watermain/Wastewater


SHEET NUMBER




Checked: DB Approved: RG

ISO A3 297mm x 420mm

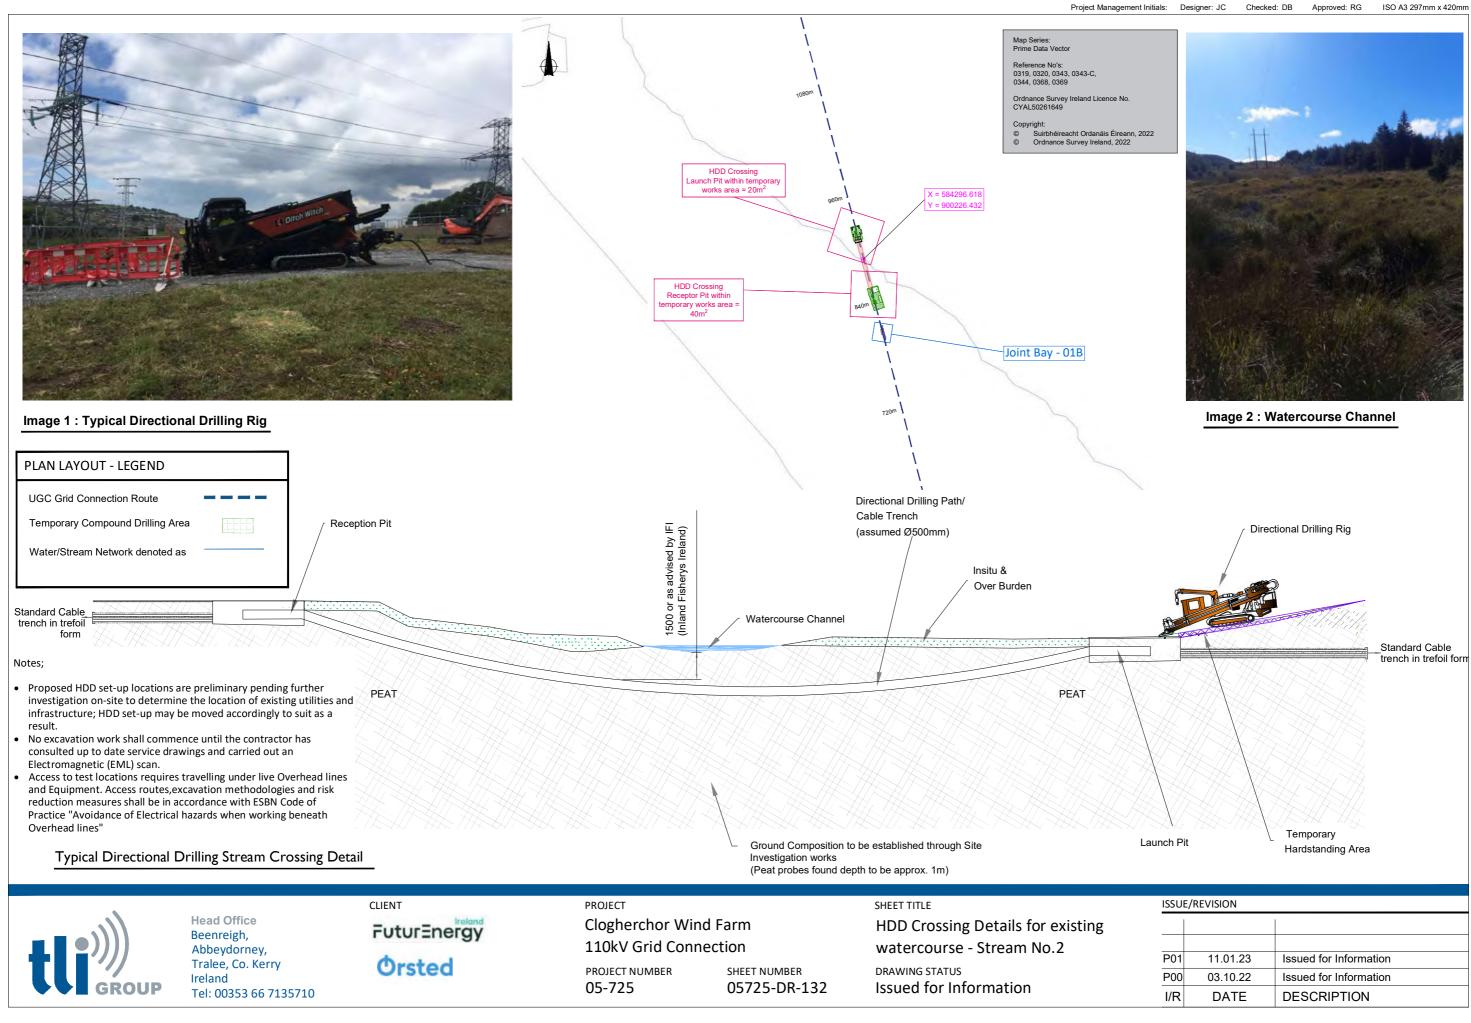

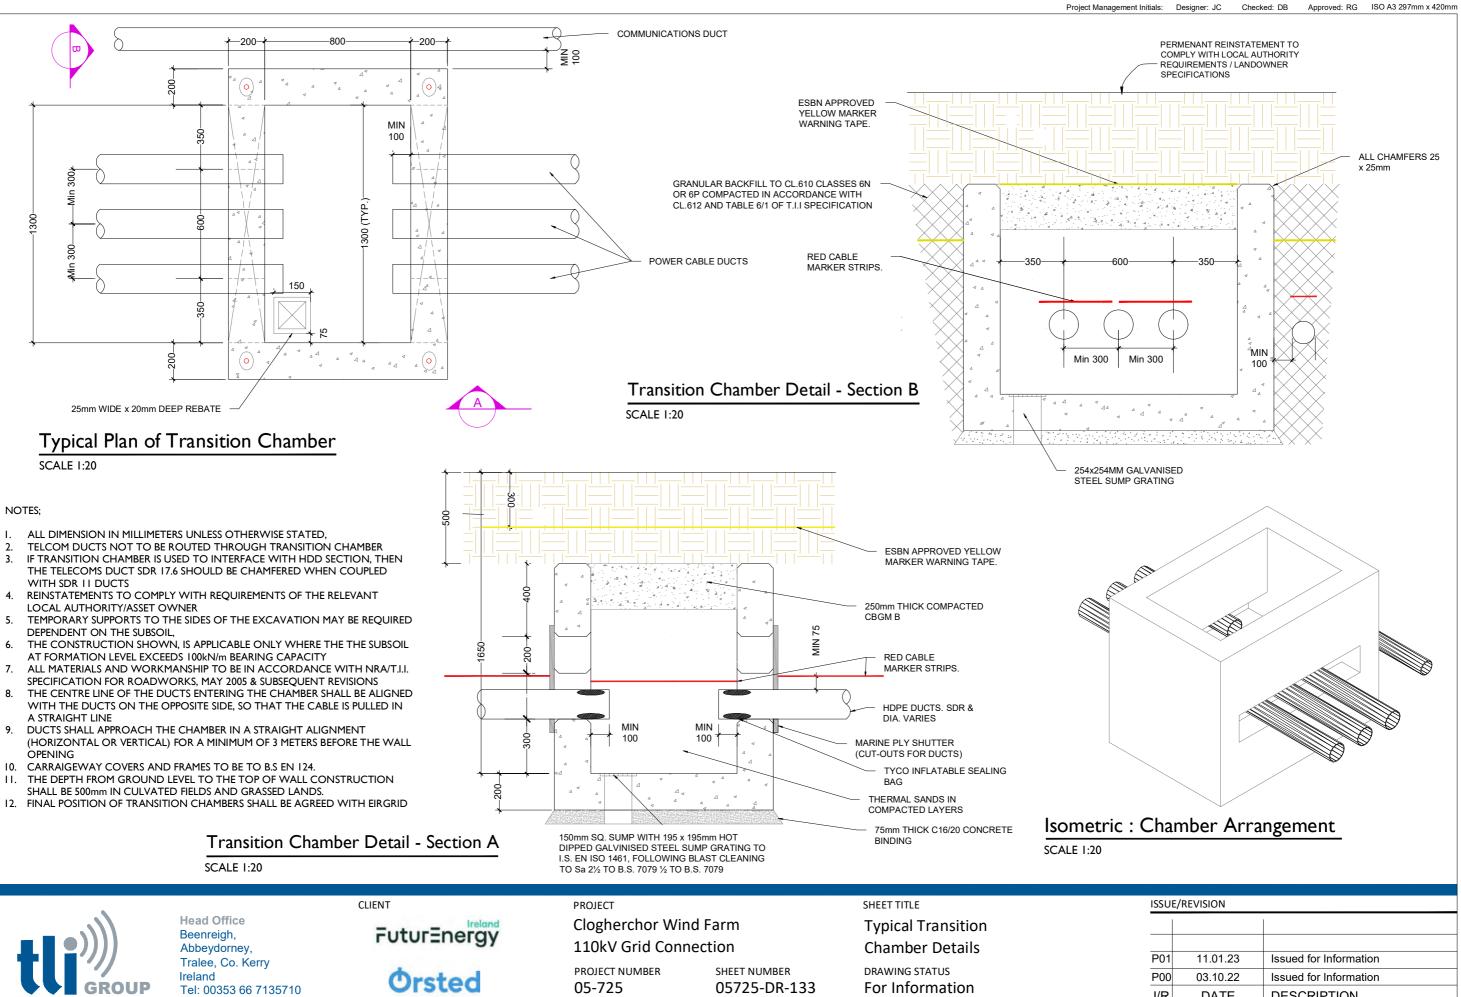

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NOTES: -

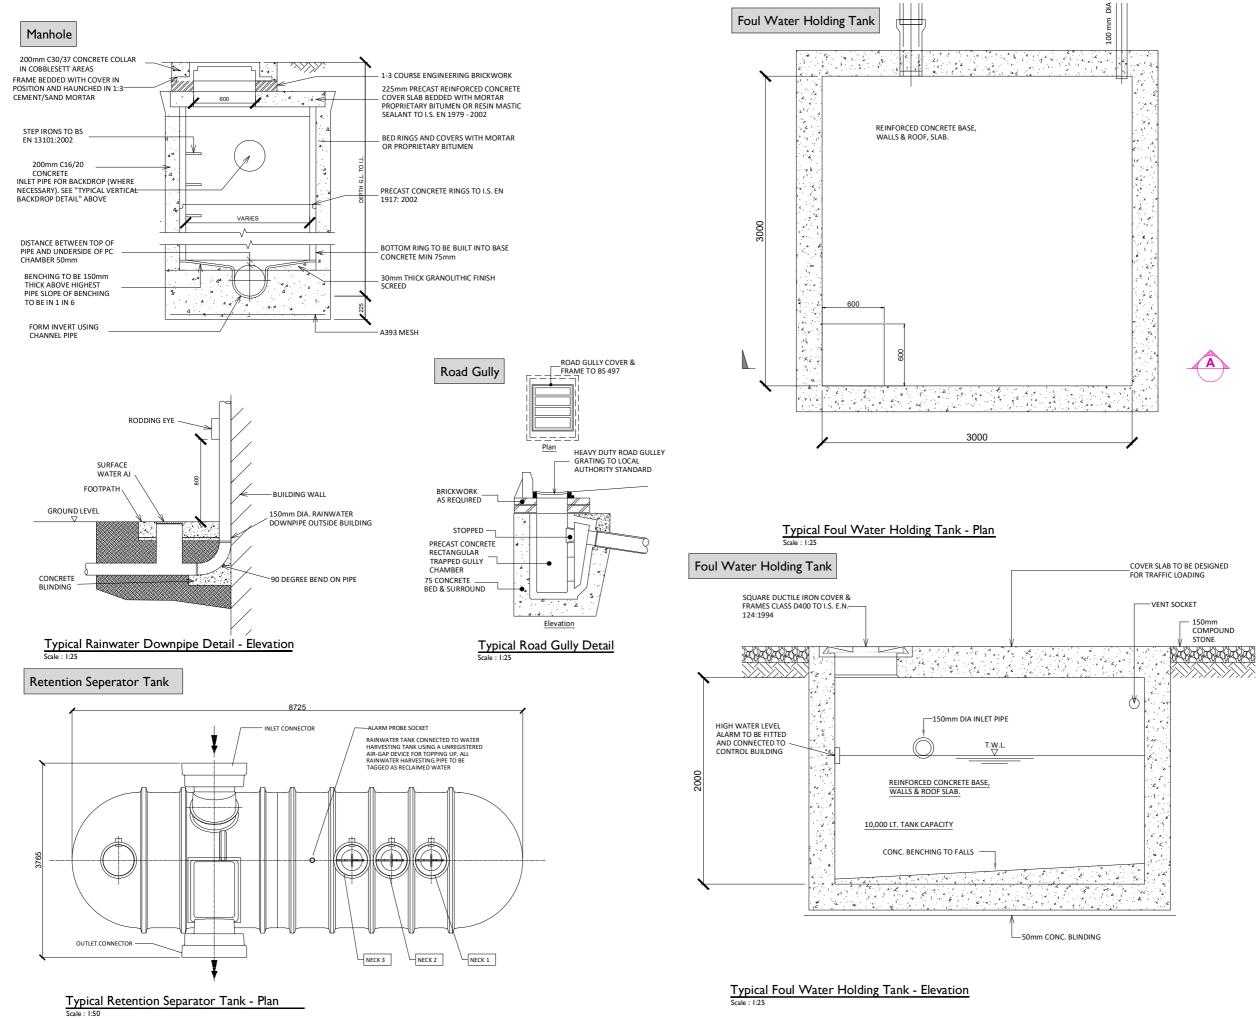- This drawing is to be read in conjunction with relevan engineering drawings, specifications and reports
- Dimensions are in millimeters, unless noted otherwise
- Drawings are not to be scaled use figured dimensions only

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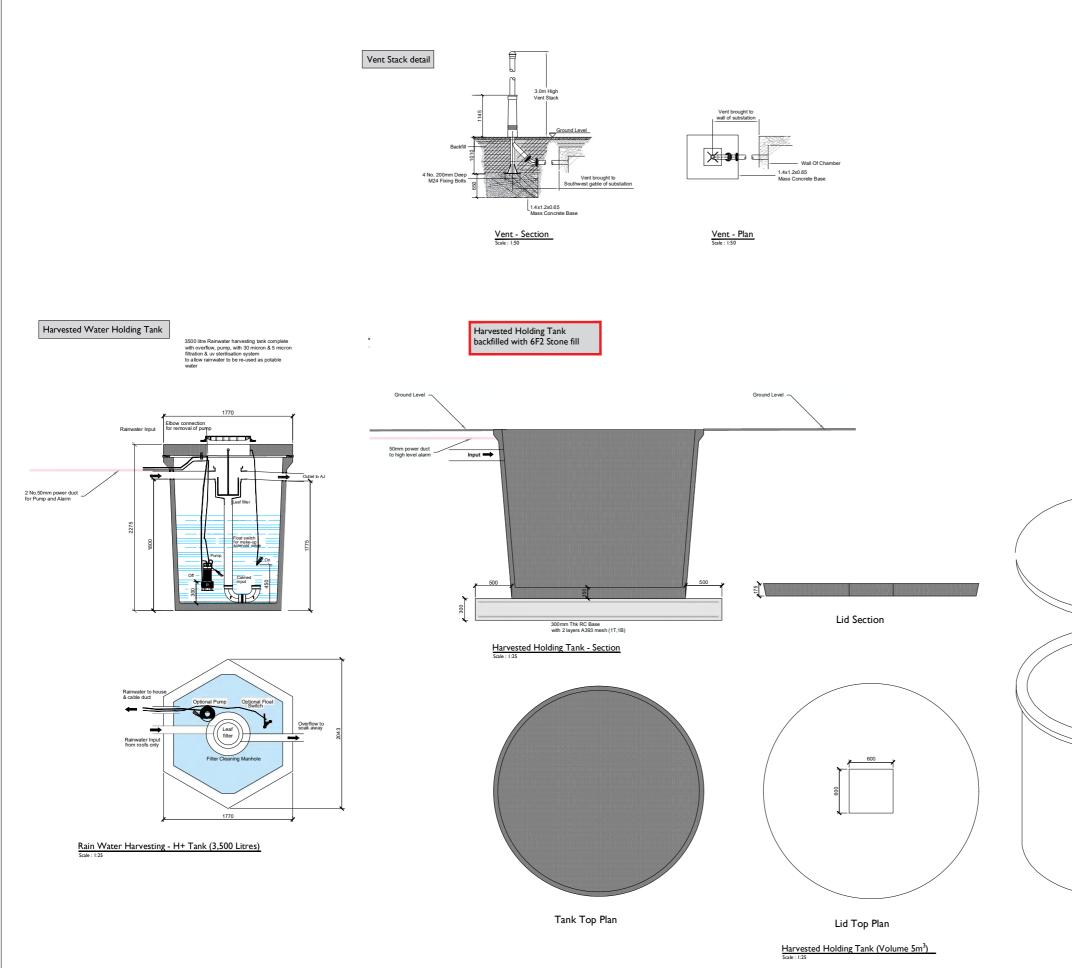
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PROJECT NUMBER		

05-725

SHEET TITLE

Substation Compound drainage, Rentention seperator tank, Foul water holding tank details SHEET NUMBER







Head Office Beenreigh, Abbeydorney, Tralee, Co. Kerry Ireland Tel: 00353 66 7135710

Regional Office Basepoint Business Centre Stroudley Road, Basingstok Hampshire, RG24 8UP, UK Tel: 00 44 12564

PROJECT

Clogherchor Wind Farm 110kV Grid Connection

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05-725

SHEET TITLE

Rain Water Harvesting Tank & Vent details

SHEET NUMBER

